

code summary & project data

ADDRESS: 130 VASONA OAKS DR, LOS GATOS, CA 95032

CODES: CBC 2022 CPC 2022 CPC 2022
CEC 2022 CMC 2022 2022 TITLE 24 CALIFORNIA ENERGY CODE

CONSTRUCTION TYPE: V-B (CBC 602.5-VB & TABLE 601)

OCCUPANCY: R3 & U ZONING: RM 5-12 APN: 42442008 FLOOD ZONE: X

JURISDICTION: PLANNING AND BUILDING: CITY OF LOS GATOS

EXISTING USE: SINGLE FAMILY HOME - NON SPRINKLERED - ONE STORY

LOT SIZE: 1,977 S.F.

FIRST FLOOR:

A. (E) HOUSE: 678 S.F.

B. AREA OF WORK: 126 S.F.

SECOND FLOOR:

A. (E) HOUSE: 1087 S.F.

B. AREA OF WORK: 786 S.F.

C. NEW ADDITION: 91 S.F.

MEZZANINE/THIRD FLOOR:

A. (E) HOUSE: 172 S.F. - 64 S.F. = 108 S.F.

B. AREA OF WORK: 108 S.F.

C. NEW ADDITION-INTERIOR: 220 S.F.

EXISTING GARAGE: 464 S.F.

A. EXISTING GARAGE: 464 S.F.

B. AREA OF WORK: 40 S.F.

DEFERRED SUNROOM: 231 S.F.

EXISTING COVERED PATIO: 148 S.F.

NEW COVERED PATIO: 173 S.F.

SCOPE OF WORK:

FIRST FLOOR:

1. RECONFIGURE LAUNDRY ROOM

2. REMOVE EXISTING DECK, CREATE NEW SUNROOM.

3. REMOVE EXISTING KITCHEN, CREATE NEW KITCHEN

4. REMOVE EXISTING BATHROOM AND W.I.C. CREATE NEW BATHROOM

5. REMOVE EXISTING STEP, CREATE NEW W.I.C.

THIRD FLOOR:

6. REMOVE EXISTING OFFICE, CREATE NEW BATHROOM

general notes

1. PERMIT IS REQUIRED FOR ELECTRICAL WORK, MECHANICAL WORK AND PLUMBING WORK.
2. WINDOWS MUST PROVIDE: (CBC 1026.2, 1026.3 AND 1026.5)
A) A MINIMUM 57 SQUARE FEET OR CLEAR OPENABLE AREA.
B) A MINIMUM CLEAR WIDTH OF 20". MINIMUM CLEAR HEIGHT OF 24".
C) A FINISHED SILL HEIGHT NOT MORE THAN 44" ABOVE THE FLOOR.
D) DIRECT OPENING TO PUBLIC WAY OR YARD/COURT OPENING TO PUBLIC WAY.
3. SAFETY GLAZING (TEMPERED GLASS) IS REQUIRED (CBC 2406.3) FOR WINDOWS:
A) ADJACENT TO BATHTUBS, SHOWERS, HOT TUBS, WHIRLPOOLS, AND SAUNAS, AND WITHIN 60" OF THE FLOOR.
B) WITHIN A 24" ARC OF EITHER VERTICAL EDGE OF DOORS IN THE CLOSED POSITION AND WITHIN 60" OF THE FLOOR.
C) WITHIN 18" VERTICALLY AND 36" HORIZONTALLY OF A WALKING SURFACE, WHERE THE INDIVIDUAL PANE IS GREATER THAN 9 FT. AND THE TOP EDGE IS GREATER THAN 36" ABOVE THE FLOOR.
D) ADJACENT TO STAIRWAYS, RAMPS, AND LANDINGS, OR WITHIN 5'-0" HORIZONTALLY OF THE BOTTOM OF STAIRWAYS, WHERE THE BOTTOM EDGE IS WITHIN 60" OF THE WALKING SURFACE.

electrical notes

1. WALL RECEPTACLES: ELECTRICAL RECEPTACLES SHALL BE PROVIDED SO THAT NO POINT ALONG THE FLOOR LINE IN ANY WALL SPACE, 2'-0" OR MORE IN WIDTH, IS MORE THAN 6'-0" FROM OUTLET. FIXED GLAZED PANELS IN EXTERIOR WALLS ARE CONSIDERED WALL SPACE. CEC ARTICLE 210-52(a).
2. BATHROOM RECEPTACLES: AT LEAST ONE WALL RECEPTACLE SHALL BE INSTALLED IN EACH BATHROOM WITHIN 36" OF THE OUTSIDE EDGE OF THE LAVATORY. CEC ARTICLE 210-52(b).
3. OUTDOORS RECEPTACLES: FOR A SINGLE-FAMILY DWELLING AND EACH DWELLING UNIT OF A DUPLEX, AT LEAST ONE ELECTRICAL RECEPTACLE ACCESSIBLE AT GRADE LEVEL AND NOT MORE THAN 6'-6" ABOVE GRADE LEVEL SHALL BE INSTALLED AT FRONT AND BACK OF BUILDING. CEC ARTICLE 210-52(c).
4. HEIGHT ABOVE FINISHED FLOOR OR WORKING SURFACE: THE CENTER OF 15, 20, AND 30-AMPERE RECEPTACLES SHALL BE INSTALLED NOT LESS THAN 12" ABOVE THE FLOOR OR WORKING SURFACE. CEC ARTICLE 210-52(d).
5. GROUND-FAULT CIRCUIT-INTERRUPTERS (GFCI): GFCI PROTECTED RECEPTACLES SHALL BE INSTALLED IN BATHROOMS, GARAGES, NON-HABITABLE ACCESSORY BUILDING WITH ELECTRICAL POWER, UNFINISHED BASEMENT, OUTDOOR WITH DIRECT ACCESS TO GRADE, ROOF TOPS, AT KITCHEN COUNTERTOPS AND WITHIN 6'-0" OF A WET BAR SINK. CEC ARTICLE 210-8.
6. WEATHER PROTECTION: ELECTRICAL RECEPTACLES INSTALLED OUTDOORS WHERE EXPOSED TO WEATHER OR IN OTHER HET LOCATIONS SHALL BE IN A WEATHERPROOF ENCLOSURE. CEC ARTICLE 410-57.
7. LIGHTING: AT LEAST ONE WALL SWITCH-CONTROLLED LIGHT OUTLET IS REQUIRED IN EACH HABITABLE ROOM, BATHROOM, HALLWAY, STAIRWAY, GUEST ROOM, ATTACHED GARAGE AND DETACHED GARAGE WITH ELECTRICAL POWER, AND AT OUTDOOR ENTRANCES IN HABITABLE ROOMS OTHER THAN KITCHEN AND BATHROOMS ONE OR MORE RECEPTACLES CONTROLLED BY A WALL SWITCH ARE PERMITTED. CEC ARTICLE 210-70(a).
8. HALLWAY RECEPTACLES: AN ELECTRICAL OUTLET SHALL BE PROVIDED IN EACH HALLWAY OF 10'-0" OR MORE IN LENGTH. HALLWAY LENGTH IS AS MEASURED ALONG THE CENTERLINE WITHOUT PASSING THROUGH A DOORWAY. CEC ARTICLE 210-52(h).
9. ALL BRANCH CIRCUITS THAT SUPPLY 125-VOLT, SINGLE PHASE 15 AND 20 AMPERE RECEPTACLE AND GFCI PROTECTED OUTLETS INSTALLED IN DWELLING UNITS, SHALL BE PROTECTED BY AN ARC-FAULT CIRCUIT INTERRUPTER (AFCI) LISTED TO PROTECT THE ENTIRE BRANCH CIRCUIT PER CEC.
10. ALL PHONE LINES TO BE (2) CATEGORY 5 TWISTED PAIR LINES & CABLE LINES ARE TO BE HOME RUN TO BOX IN RESIDENCE. COORDINATE SYSTEM WITH OWNER.
11. LIGHT FIXTURES OVER TUB SHALL BE PROTECTED BY A GFCI & MEET THE FOLLOWING REQUIREMENTS: RECESSED FIXTURES WITH A GLASS OR PLASTIC LENS & NONMETALLIC OR ELECTRICALLY ISOLATED TRIM, & SHALL BE SUITABLE FOR USE IN DAMP LOCATION.
12. ALL LIGHTING AS HIGH EFFICACY (I.E. PIN-BASED CFL, PULSE-START MR, HPS, GU-24 SOCKETS OTHER THAN LEADS, LED LUMINAIRES WITH INTEGRAL SOURCE, ETC.). CEC TABLE 150-24.
13. AT LEAST ONE FIXTURE IN EACH BATHROOM CONTROLLED BY A VACANCY SENSOR OR OCCUPANCY SENSOR PROVIDED THE OCCUPANCY SENSOR THAT IS INITIALLY PROGRAMMED LIKE A VACANCY SENSOR (MANUAL-ON OPERATION). CEC 150.0(K)(2).
14. ALL OUTDOOR LIGHTING ATTACHED TO THE BUILDING SHALL HAVE MOTION-SENSOR + PHOTO-CONTROL.
15. ALL 125-VOLT 15 AND 20 AMPERE RECEPTACLE OUTLETS SHALL BE LISTED TAMPER RESISTANT RECEPTACLES PER CEC 408.12.
16. BATHROOM EXHAUST FANS SHALL BE SEPARATELY SWITCHED FROM ANY LIGHTING PER TITLE 24 SECTION 150.0(K)(2).
17. LIGHTING IN GARAGES, LAUNDRY ROOMS, & UTILITY ROOMS SHALL BE HIGH EFFICACY & CONTROLLED BY VACANCY SENSORS PER TITLE 24 SECTION 150.0(K)(2).
18. SCREW-BASED PERMANENTLY INSTALLED LIGHT FIXTURES MUST CONTAIN SCREW-BASED JAB (JOINT APPENDIX B) COMPLIANT LAMPS. JAB COMPLIANT LIGHT SOURCES MUST BE MARKED AS "JAS-2019" OR "JAS-2019-E" ("JAS-2019-E" LUMINAIRE ARE DESIGNATED APPROPRIATE FOR USE IN ENCLOSED LUMINAIRE) ADVISORY: JAB-2019-E MARKED LUMINAIRES ARE STILL ALLOWED FOR USE THROUGH THE END OF THE 2022 CODE CYCLE. CEC 150.0(K)(2).
19. AMEND THE NOTES TO SPECIFY ALL JAB COMPLIANT LIGHT SOURCES IN THE FOLLOWING LOCATIONS ARE CONTROLLED BY VACANCY SENSORS OR DIMMERS (EXCEPT IN CLOSETS LESS THAN 70 SF AND HALLWAYS). CEC 150.0(K)(2):
 - CEILING RECESSED DOWNLIGHT LUMINAIRES.
 - LED LUMINAIRES WITH INTEGRAL SOURCES.
 - PIN-BASED LED LAMPS (I.E. MR, G, AR-111, E TC).
 - QU-24 BASED LED LIGHT SOURCES.
20. AT LEAST ONE FIXTURE IN THE GARAGE CONTROLLED BY A VACANCY SENSOR OR OCCUPANCY SENSOR PROVIDED THE OCCUPANCY SENSOR THAT IS INITIALLY PROGRAMMED LIKE A VACANCY SENSOR (MANUAL-ON OPERATION). CEC 150.0(K)(2).
21. AT LEAST ONE FIXTURE IN EACH UTILITY ROOM CONTROLLED BY A VACANCY SENSOR OR OCCUPANCY SENSOR PROVIDED THE OCCUPANCY SENSOR THAT IS INITIALLY PROGRAMMED LIKE A VACANCY SENSOR (MANUAL-ON OPERATION). CEC 150.0(K)(2).

PROJECT DATA

	EXISTING	PROPOSED
LOT SIZE	1,977 S.F.	1,977 S.F.
LOT COVERAGE	66%	73.40%
FIRST FLOOR LIVING AREA S.F.:	678 S.F.	0 S.F.
SECOND FLOOR LIVING AREA S.F.:	1087 S.F.	322 S.F. ADDITION = 1409
THIRD FLOOR LIVING AREA S.F.:	236 S.F.	329 S.F. ADDITION
TOTAL LIVING AREA S.F.	2001 s.f.	2416 S.F.
FIRST FLOOR PATIO	148 s.f.	173 s.f. ADDITION + 148 S.F. = 321 S.F.
FAR - HOME	101.21%	122.20%
FAR - GARAGE	23.30%	NO CHANGE
LOT COVERAGE	1290 S.F.	1463 S.F.

1. PROVIDE 24" CLEAR IN FRONT OF TOILET AND 30" MINIMUM WIDE TOILET COMPARTMENT. CBC SECTION 2904, CPC SECTION 408.6.
2. PROVIDE MINIMUM 1.024 SQUARE INCH AREA AND 30" DIAMETER IN SHOWER COMPARTMENT. CPC SECTION 412.7.
3. WALL COVERINGS IN SHOWERS AND TUBS: TILE OR EQUAL TO 12" ABOVE DRAIN. ENCLOSURES MUST BE OF APPROVED SAFETY GLAZING AND DOORS MUST SWING OUT OF SHOWERS. WINDOWS IN ENCLOSURE WALLS SHALL BE LABELED SAFETY GLAZING WHEN LESS THAN 60" ABOVE THE DRAIN. CBC SECTION 2612, CPC SECTION 412.7.
4. PROVIDE A 12" MINIMUM ACCESS PANEL TO BATHTUB TRAP CONNECTION UNLESS PLUMBING IS WITHOUT SLIP JOINTS. CPC SECTION 406.2.
5. PROVIDE LOW FLOW TOILETS (1.28 GALLON PER FLUSH), SHOWERSHEAD (1.8 GPM) AND FAUCETS: KITCHEN: 1.8 GPM LAVATORY: 1.2 GPM. CPC SECTION 402.
6. SHOWER AND TUB-SHOWER COMBINATIONS SHALL HAVE INDIVIDUAL CONTROL VALVES OF THE PRESSURE BALANCE OR THE THERMOSTATIC MIXING VALVE TYPE. CPC 408.3.

sheet index

ARCHITECTURAL

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- A0.1 STREET SCAPE ELEVATIONS
- A0.2 SHADOW PLAN STUDY
- C1.0 CALGREEN REQUIREMENTS
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- A2.0 EXISTING AND DEMO SECOND FLOOR AND THIRD FLOOR PLANS
- A3.0 PROPOSED FIRST FLOOR PLANS
- A4.0 PROPOSED SECOND FLOOR PLANS
- A5.0 PROPOSED THIRD FLOOR PLANS
- A6.0 DEMO AND NEW ELEVATIONS
- A7.0 SECTIONS, DOOR AND WINDOW SCHEDULE, AND DETAIL
- A8.0 EXISTING PHOTO
- A9.0 MATERIAL BOARD

vicinity map



project team

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UNION CITY CA 94087
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legend

- (E) WALL TO REMAIN
- (E) WALL, DOORS AND WINDOWS TO REMOVE
- EXTERIOR ELEVATION REFERENCE TAG
- DETAIL NUMBER
- SHEET NUMBER

demo sheet notes

- A. REMOVE EXISTING DOORS (SHOWN DASHED).
- B. REMOVE EXISTING DOOR (SHOWN DASHED). INFILL WITH NEW WALL AND MATCH TO ALIGN WITH EXISTING ADJACENT.
- C. REMOVE EXISTING DOOR (SHOWN DASHED). REPLACE WITH NEW DOOR.
- D. REMOVE EXISTING WINDOW (SHOWN DASHED).
- E. REMOVE EXISTING WINDOWS (SHOWN DASHED). REPLACE WITH NEW DOOR.
- F. REMOVE EXISTING WINDOWS (SHOWN DASHED). FILLED WITH NEW WALL.
- G. REMOVE THIS PORTION OF EXISTING WALL.
- H. REMOVE (E) KITCHEN UPPER & LOWER CABINET, COUNTERTOP, FAUCET, STOVE, REFRIGERATOR, DISHWASHER, DISPOSAL, & SINK. CAP & SALVAGE (E) PLUMBING & GAS LINE FOR NEW APPLIANCES. SEE PROPOSED FLOOR PLAN FOR NEW LOCATION.
- I. REMOVE PLUMBING FIXTURE AND ACCESSORIES: CAP PLUMBING LINES BEHIND WALLS UNDER FLOOR.
- J. REMOVE ATTIC ACCESS (SHOWN DASHED).
- K. REMOVE WATER HEATER (SHOWN DASHED).
- L. REMOVE AIR CONDITIONER.
- M. REMOVE EXISTING POST. SEE S.D.
- N. REMOVE EXISTING STEP.
- O. REMOVE DECK (SHOWN DASHED).
- P. (E) SKYLIGHT TO REMAIN.
- Q. (E) CRAWL SPACE ACCESS TO REMAIN.

PROJECT DATA


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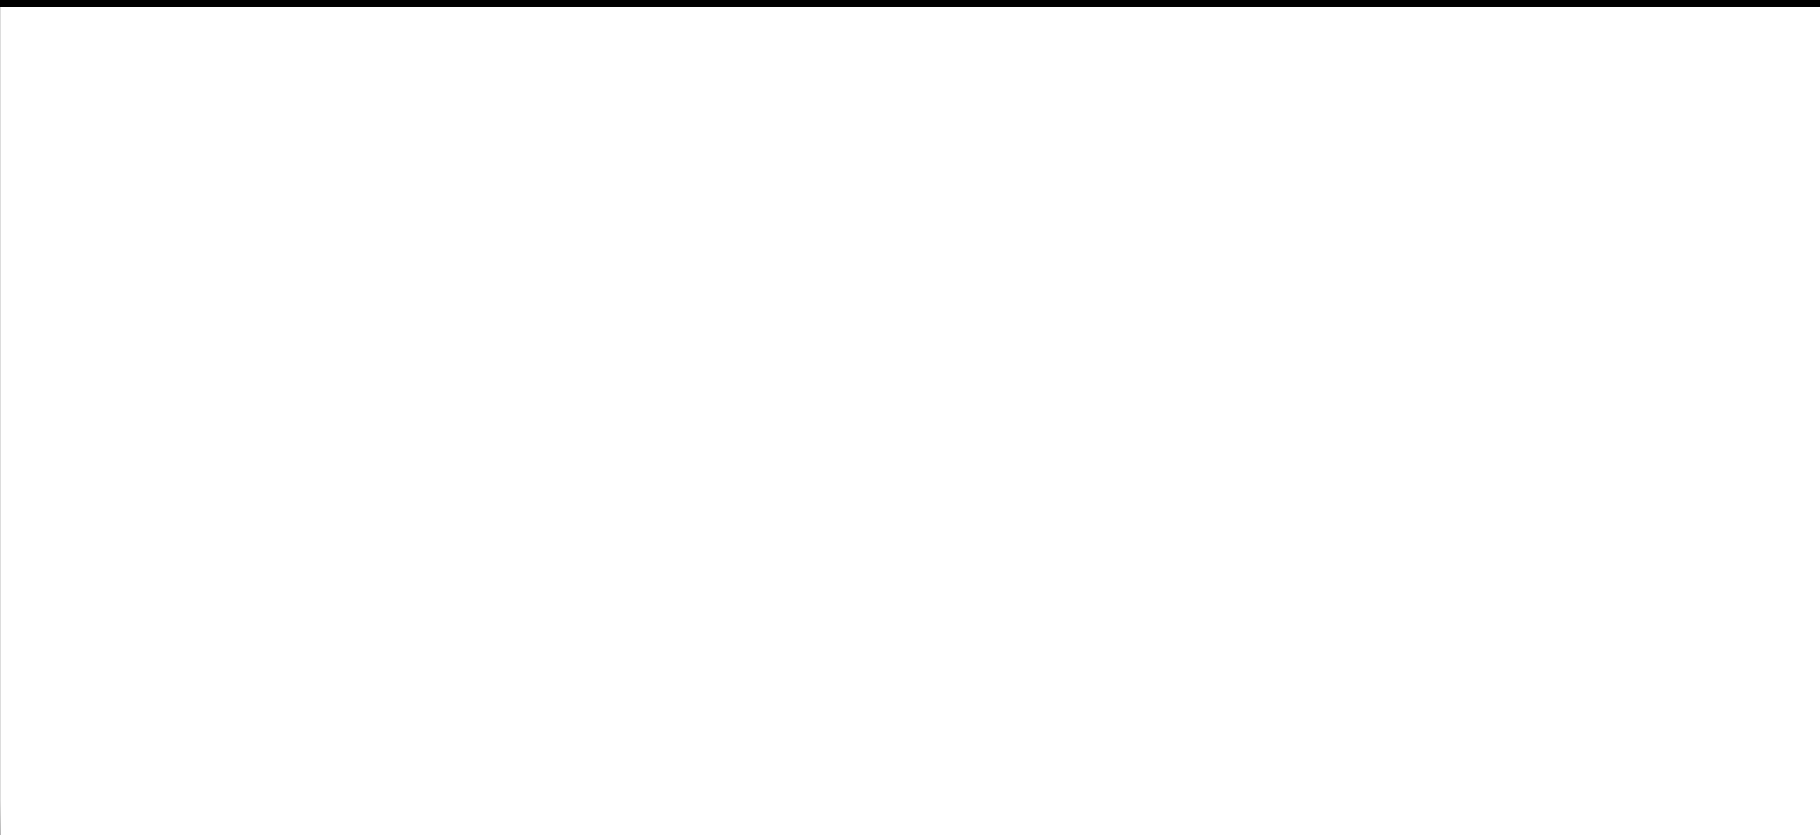
EXISTING AND DEMO FIRST FLOOR PLAN



site plan legend



SITE PLAN WITH NEW FLOOR PLAN

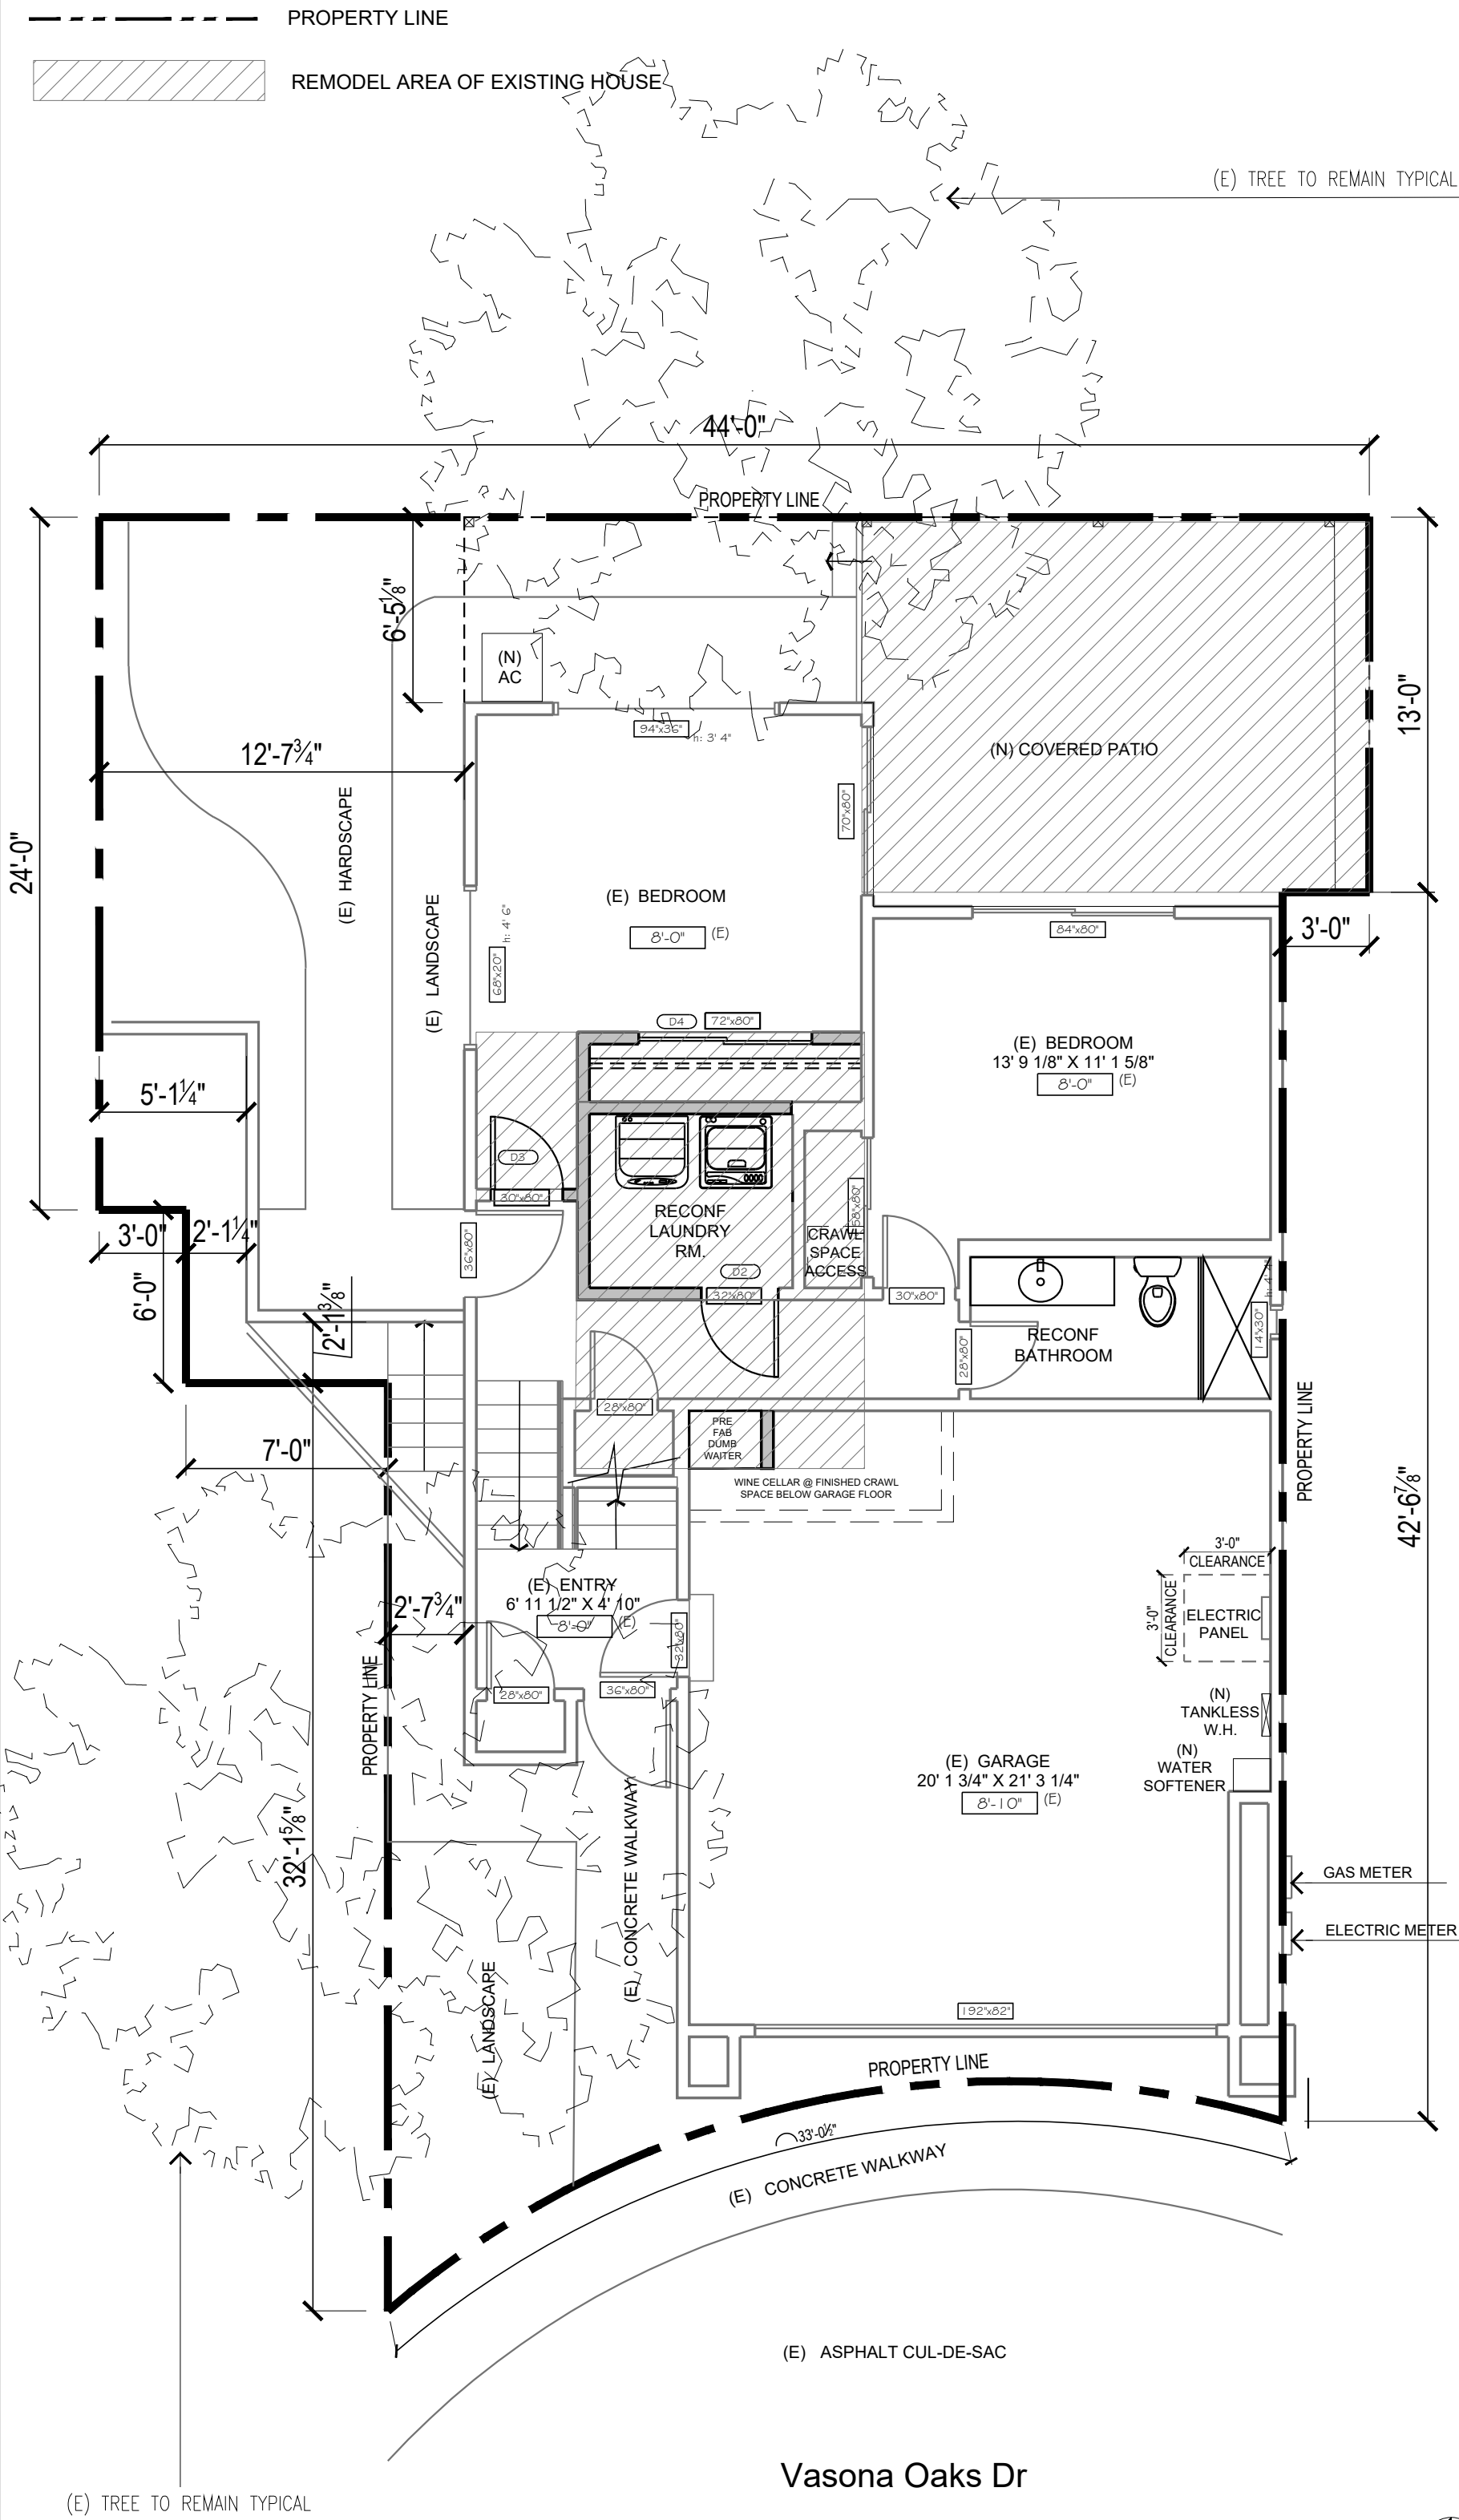

consultant

consultant

- general notes
1. This sheet is part of a set and is not to be used alone.
 2. This sheet is not to be used for construction unless the designer's signature appear on drawings and status box indicates drawings have been released for construction.
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Residence

Remodeling & Addition

130 Vasona Oaks Dr,
Los Gatos, CA 95032

#	description	date
1	planning comments response	6.9.2025
2	planning comments resp.	6.19.2025
3		
4		
5		
6		
	client review	date
	plan check	
	bidding	
	construction	

date 4.19.2024

proj num

proj mgr

proj arch

scale AS NOTED

PROJECT DATA, SITE PLAN AND
EXISTING AND DEMO FIRST FLOOR
PLAN

sheet number
A1.0

demo sheet notes

- A. REMOVE EXISTING DOORS (SHOWN DASHED).
B. REMOVE EXISTING DOOR (SHOWN DASHED). INFILL WITH NEW WALL AND MATCH TO ALIGN WITH EXISTING ADJACENT.
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I. REMOVE PLUMBING FIXTURES AND ACCESSORIES. CAP PLUMBING LINES BEHIND WALLS/UNDER FLOOR.
J. REMOVE ATTIC ACCESS (SHOWN DASHED).
K. REMOVE WATER HEATER (SHOWN DASHED).
L. REMOVE AIR CONDITIONER.
M. REMOVE EXISTING POST. SEE S.S.D.
N. REMOVE EXISTING STEP.
O. REMOVE DECK (SHOWN DASHED).
P. (E) SKYLIGHT TO REMAIN.
Q. (E) CRAWL SPACE ACCESS TO REMAIN.

new sheet notes

1. NEW RELOCATED WASHER. PROVIDE POWER.
2. PROVIDE WATER HAMMER ARRESTORS AT ALL APPLIANCES THAT HAVE QUICK-ACTING VALVES (I.E. DISHWASHER HOT WATER LINE AND THE HOT/COLD WATER LINES FOR THE CLOTHES WASHER.) 2022CPC 609.10
3. PROVIDE NEW DISHWASHER. PROVIDE POWER AND PLUMBING. ON THE DISHWASHER SIDE OF THE DISHWASHER PROVIDE A LISTED AIR GAP FITTING. LISTED AIR GAPS SHALL BE INSTALLED WITH THE FLOOD LEVEL MARKING AT OR ABOVE THE FLOOD LEVEL OF THE SINK OR DRAIN BOARD WHICHEVER IS HIGHER PER CPC SECTION 807.3.
4. INSTALLATION OF A DEDICATED FUEL SHUT OFF VALVE SHALL BE WITHIN 6'-0" OF THE GAS APPLIANCE IT SERVES. CPC 230.79. EARTHQUAKE-ACTUATED GAS SHUTOFF VALVES DESIGNED TO AUTOMATICALLY SHUT OFF THE GAS AT THE LOCATION OF THE VALVE IN THE EVENT OF A SEISMIC DISTURBANCE AND CERTIFIED BY THE STATED ARCHITECT AS CONFORMING TO CALIFORNIA CODE OF REGULATIONS, TITLE 24, PART 12, CHAPTER 12.710.47, SHALL BE INSTALLED IN ALL NEW BUILDINGS AND IN EXISTING BUILDINGS THAT UNDERGO ALTERATIONS OR ADDITIONS THAT EXCEED \$10,000.
5. PROVIDE NEW GAS COOKING RANGE (PROVIDE POWER) WITH NEW EXHAUST HOOD (PROVIDE POWER) WITH A MIN. VENTILATION EXHAUST RATE OF 100 CFM. HOUSEHOLD COOKING APPLIANCES SHALL HAVE A VERTICAL CLEARANCE ABOVE THE COOKING TOP OF NOT LESS THAN THIRTY - 30" INCHES TO COMBUSTIBLE MATERIAL OR METAL CABINETS, EXCEPT WHERE 24 INCHES IS ALLOWED PER CODE OR MANUFACTURER'S SPECIFICATION. CMC 920.3.2.
6. RANGE HOODS SHALL BE PERMITTED TO BE CORD-AND-PLUG-CONNECTED WITH A FLEXIBLE CORD IDENTIFIED AS SUITABLE FOR USE ON RANGE HOODS IN THE INSTALLATION INSTRUCTIONS OF THE APPLIANCE MANUFACTURER, WHERE ALL THE FOLLOWING CONDITIONS ARE MET: THE FLEXIBLE CORD IS TERMINATED WITH A GROUNDING-TYPE ATTACHMENT PLUG; THE LENGTH OF THE CORD IS 18 INCHES TO 4 FEET; RECEPTACLES ARE LOCATED TO PROTECT AGAINST PHYSICAL DAMAGE TO THE FLEXIBLE CORD; THE RECEPTACLES IS ACCESSIBLE. THE RECEPTACLE IS SUPPLIED BY AN INDIVIDUAL BRANCH CIRCUIT.
7. IF OCCURS ELECTRIC STOVES AND OVENS SHALL BE SUPPLIED WITH 40- OR 50-AMP BRANCH CIRCUIT.
8. PROVIDE NEW SINK WITH CALGREEN COMPLIANT FAUCET WITH NEW GARBAGE DISPOSAL (PROVIDE POWER).
9. NEW REFRIGERATOR/ICE MAKER/WINE COOLER (PROVIDE POWER AND ICE MAKER OUTLET BOX AND CONNECT).
10. NEW SOLID SINKER TOP WITH UPPER AND LOWER CABINETS.
11. COUNTERTOP AND WHERE THE COUNTERTOP DOES NOT EXTEND MORE THAN 6 INCHES BEYOND ITS BASE.
12. NEW SOLID SURFACE COUNTER KITCHEN ISLAND AND BAR COUNTER WITH BASE CABINET.
13. COMBINATION TYPE ARC-FAULT CIRCUIT INTERRUPTER SHALL PROTECT ALL RECEPTACLES IN ALL BEDROOMS, DINING ROOMS, LIVING ROOMS, PARLOUS, LIBRARIES, DENIS, SUNROOMS, RECREATION ROOMS, CLOSETS, KITCHENS, LAUNDRY AREAS, HALLWAYS OR SIMILAR ROOMS OR AREAS WITH BRANCH CIRCUITS THAT SUPPLY 125 VOLT, SINGLE-PHASE, 15 AND 20-AMPERE RECEPTACLE OUTLETS, AND BE READILY ACCESSIBLE. 2022 CEC SECTION 210.12
14. TWO 20-AMP GFCI PROTECTED CIRCUITS WILL BE PROVIDED IN THE KITCHEN COUNTER AND ISLAND OUTLETS AND SHALL COMPLY WITH ART. 210.52 (C) (6) EXCEPTION TO (6) CEC 2022
15. LIGHTING INTEGRAL TO EXHAUST FANS SHALL BE CONTROLLED SEPARATELY FROM THE EXHAUST FANS. 150.0 (K) 28.
16. LIGHTING SHALL HAVE VACUUM SENSOR. EXHAUST FAN SHALL BE 50 CFM MIN.
17. PROVIDE WATER CLOSETS TO BE MAX. 1.28 GAL. PER FLUSH.
18. SHOWER/TUB W/ FULL HEIGHT TILE WALLS & TEMPERED GLASS ENCLOSURE. USE DRUTRANE 4,000 WATERPROOFING MEMBRANE OVER 1/2" WONDER BOARD & WALLS, CEILING, & FLOOR.
19. NEW SOLID SURFACE (NON-SLIP RESISTANT) SHOWER PAN AND WALLS.
20. PROVIDE SHOWER FINISHED TO 72" ABOVE DRAIN. PROVIDE PRESSURE OR THERMOSTATIC MIXING VALVE @ SHOWER AND ADJUSTABLE, WHICH LIMITS WATER TEMPERATURE TO 120°F. SHOWER HEAD SHALL NOT EXCEED 1.8 GALLONS PER MINUTE AT 80 PSI.
21. NEW SINK AND FAUCET. PROVIDE FAUCET TO BE MAX 1.2 GPM AT 60 PSI. METERING FAUCETS SHALL NOT EXCEED 0.2 GALLONS PER METERING CYCLE.
22. WINDOW MODIFICATIONS: REPLACEMENT AND NEW WINDOWS SHALL HAVE A U-FACTOR EQUAL TO 0.30
23. PROVIDE NEW COMBO UNIT SMOKE DETECTOR AND CARBON MONOXIDE DETECTOR W/BATTERY BACK-UP IN HALLWAY.
24. PROVIDE NEW 24" X 48" FLAT PROFILE SKYLIGHT.
25. PROVIDE NEW TANKLESS WATER HEATER.
26. NEW W/LL 3/4"X2" ATTIC ACCESS.
27. NEW PREFABRICATED STAIRS (NOT USE)
28. NEW P-1 POSTS ON CONC. BASE 2" ABOVE FINISHED GRADE (TYP.)
29. NEW DECKING OVER FRAMING. S.S.D. FOR FRAMING DETAILS.
30. NEW AIR CONDITIONER.

KITCHEN GENERAL NOTES (2022 CBC REQUIREMENTS):

- WATER CONSERVING PLUMBING FIXTURES REQUIREMENTS:
• KITCHEN FAUCETS SHALL HAVE A MAXIMUM FLOW RATE OF 1.8 GALLONS PER MINUTE. FLOW MAY TEMPORARILY INCREASE TO 2.2 GALLONS PER MINUTE, BUT MUST DEFAULT TO A MAXIMUM OF 1.8 GALLONS PER MINUTE. (CGS&C 4.303.1.4.4)
• PRIOR TO FINAL INSPECTION ALL NON-COMPLIANT PLUMBING FIXTURES SHALL BE UPGRADED WITH WATER-CONSERVING FIXTURES AS REQUIRED BY CIVIL CODE 1101.1. A COMPLETED AND SIGNED CERTIFICATE OF COMPLIANCE SHALL BE PROVIDED TO THE BUILDING INSPECTOR.
ELECTRICAL REQUIREMENTS:
• RECEPTACLE OUTLETS SHALL BE INSTALLED SO THAT NO POINT ALONG THE WALL COUNTERTOP OR WORK SURFACE IS MORE THAN 24 INCHES FROM A RECEPTACLE IN THAT SPACE. [CEC 210.52(C)(1)]
• RECEPTACLE OUTLETS SHALL BE INSTALLED AT EACH KITCHEN COUNTERTOP AND WORK SURFACE THAT IS 12 INCHES OR UNDER. [CEC 210.52(C)(1)]
• AT LEAST ONE RECEPTACLE OUTLET SHALL BE INSTALLED AT EACH ISLAND OR PENINSULAR COUNTER SPACE WITH A LONG DIMENSION OF 24 INCHES OR GREATER AND A SHORT DIMENSION OF 12 INCHES OR GREATER. [CEC 210-52(C)(2) AND 210.52(C)(3)]
• ALL ELECTRICAL OUTLETS SERVING KITCHEN COUNTERTOPS AND DISHWASHERS SHALL BE GFCI PROTECTED. GROUND FAULT CIRCUIT INTERRUPTERS SHALL BE LOCATED IN A READILY ACCESSIBLE LOCATION. [CEC 210.8(A)(D)]
• AT LEAST TWO SEPARATE 20-AMPERE BRANCH CIRCUITS SHALL BE PROVIDED FOR SMALL KITCHEN APPLIANCES. THESE CIRCUITS ARE LIMITED TO SUPPLYING WALL AND COUNTER SPACE OUTLETS ONLY AND CANNOT SERVE DISHWASHER, MICROWAVE, RANGE HOOD, GARBAGE DISPOSAL, ETC. [CEC 210.11(C)(1) AND 210.52(B)(3)]
• ALL ADDED/REPLACED RECEPTACLES SHALL BE LISTED TAMPER-RESISTANT RECEPTACLES AND SHALL BE ARC FAULT PROTECTED. [CEC 406.12]

2022 BATHROOM REMODEL REQUIREMENTS:

1. PROVIDE WATERPROOFED MATERIAL AT SHOWER WALLS.
2. ALL RECEPTACLES SHALL BE GFCI PROTECTED AND CONNECTED TO A DEDICATED 15 AND 20 AMPS CIRCUIT. (AEC 210.8.4)
3. ALL HARDWIRED LIGHTING SHALL BE HIGH EFFICIENCY. (AEC ENERGY EFF. STANDARDS, SECTION 1500.0)
4. EXHAUST FANS ARE REQUIRED IN ALL BATHROOMS, EVEN IF AN OPERABLE WINDOW IS INSTALLED. CPC 303.5.
5. EXHAUST FANS AND LIGHTING SHALL HAVE SEPARATE CONTROL SWITCHES, EVEN IF A COMBINATION UNIT IS INSTALLED. THE EXHAUST FAN MAY NEED TO BE SUPPLIED BY A GFCI PROTECTED CIRCUIT BASED ON THE MANUFACTURER'S REQUIREMENTS. CEC 150.0 (K)(28)
6. EXHAUST FANS SHALL TERMINATE A MINIMUM OF 3 FT FROM PROPERTY LINE AND 3 FT FROM OPENINGS INTO A BUILDING. (CMC 502.2.1)
7. EXHAUST FANS AT SHOWER SHALL BE LISTED FOR WET LOCATION AND SHALL BE GFCI PROTECTED. CEC 210.8
8. SHOWER ENCLOSURE DOORS SHALL OPEN OUTWARD AND MAINTAIN 22" CLEARANCE. CPC 408.5
9. SHOWER COMPARTMENT SHALL BE A MINIMUM 1,024 SQUARE INCHES ENCOMPASSING A 30"X18" CIRCLE. CPC 408.6
10. WATER CLOSETS (MAXIMUM 1.28 GPM/LA SHALL BE CLEAR 30 INCHES WIDE 15 INCHES ON CENTER) AND 24 INCHES IN FRONT. CPC 402.5
11. SHOWER HEADS (MAXIMUM 1.8 GPM CPC 408.2 & FAUCETS (MAXIMUM 1.2 GPM CPC 407.2)
12. BATHTUB/WHIRLPOOLS AND SHOWER VALVES SHALL BE APPROVED PRESSURE-BALANCED OR THERMOSTATIC MIXING TYPE ADJUSTED TO A MINIMUM OF 120 DEGREES. CPC 408.3

legend

- (E) STUD WALL TO REMAIN
(E) WALL, DOORS AND WINDOWS TO REMOVE
(N) 2x STUD WALL - EXTERIOR WALL TO RECEIVE 2X6 WITH R-13 BATT. INSULATION SEE TITLE 24 FOR MORE INFO. EXTERIOR ELEVATION REFERENCE TAG
DETAIL NUMBER SHEET NUMBER

- DEMOLISHED WALL AREA: 139.4 sq
- NEW WALL AREA: 213.5 sq

LIGHTING REQUIREMENTS:

- ALL INSTALLED LUMINAIRES SHALL BE HIGH EFFICACY. (CEMC 150.0 TABLE 150.0.A)
- UNDER CABINET LIGHTING SHALL BE CONTROLLED SEPARATELY FROM CEILING INSTALLED LIGHTING SUCH THAT ONE CAN BE TURNED ON WITHOUT THE OTHER. (CEMC 150.0(2)(K))
- LUMINAIRES RECESSED INTO INSULATED CEILINGS:
(A) SHALL BE LISTED FOR ZERO CLEARANCE INSULATION COVER (IC RATED);
(B) SHALL INCLUDE A LABEL CERTIFYING AIR TIGHT (AT) WITH AIR LEAKAGE LESS THAN 2.0 CFM AT 75 PASCALES.
(C) SHALL BE SEALED WITH A GASKET OR CAULK BETWEEN THE LUMINARY HOUSING AND CEILING;
(D) IF RECESSED LIGHTS ARE EQUIPPED WITH BALLASTS, SHALL ALLOW BALLAST MAINTENANCE AND REPLACEMENT WITHOUT REQUIRING CUTTING OF HOLES IN THE CEILING; AND
(E) SHALL NOT CONTAIN SCREW BASE SOCKETS. (CECS SEC.150(K)(2).

SMOKE AND CARBON MONOXIDE DETECTOR

WHEN ALTERATIONS, REPAIRS OR ADDITIONS REQUIRING A PERMIT OCCUR, THE INDIVIDUAL DWELLING UNIT SHALL BE EQUIPPED WITH SMOKE ALARMS LOCATED AS REQUIRED FOR NEW DWELLINGS. (R314.2.2)

SMOKE ALARMS: DWELLINGS ARE TO BE EQUIPPED WITH SMOKE ALARMS INSTALLED IN THE FOLLOWING LOCATIONS: (CRC 314.4)

- IN EACH EXISTING SLEEPING ROOM.
- OUTSIDE EACH SEPARATE SLEEPING AREA IN THE IMMEDIATE VICINITY OF THE BEDROOMS.
- ON EACH STORY INCLUDING BASEMENTS AND HABITABLE ATTICS, NOT INCLUDING CRAWL SPACES AND UNINHABITABLE ATTICS.
- INSTALLED NOT LESS THAN 3 FEET HORIZONTALLY FROM THE DOOR OR OPENING OF A BATHROOM THAT CONTAINS A BATHTUB OR SHOWER UNLESS THIS WOULD PREVENT PLACEMENT OF A SMOKE ALARM REQUIRED BY CRC R314.3(4).
- CARBON MONOXIDE ALARMS: DWELLINGS THAT HAVE ATTACHED GARAGES WITH AN OPENING THAT COMMUNICATES WITH THE DWELLING UNIT, OR FUEL BURNING APPLIANCES, OR FIRE PLACE ARE TO BE EQUIPPED WITH CARBON MONOXIDE ALARMS INSTALLED IN THE FOLLOWING LOCATIONS: (CRC 315.3)
• OUTSIDE EACH SEPARATE SLEEPING AREA IN THE IMMEDIATE VICINITY OF THE BEDROOMS.
• ON EVERY OCCUPABLE LEVEL OF A DWELLING UNIT INCLUDING BASEMENTS.
• WHERE A FUEL-BURNING APPLIANCE IS LOCATED WITHIN A BEDROOM OR ITS ATTACHED BATHROOM. A CARBON MONOXIDE ALARM SHALL BE INSTALLED WITHIN THE BEDROOM.

ALARM INTERCONNECTION AND POWER: SMOKE AND CARBON MONOXIDE ALARMS ARE REQUIRED TO BE INTERCONNECTED SUCH THAT ACTIVATION OF ONE ALARM WILL ACTIVATE ALL OF THE ALARMS AND SHALL RECEIVE THEIR PRIMARY POWER FROM THE BUILDING WIRING. EXCEPTION: WHERE REPAIRS OR ALTERATIONS TO EXISTING BUILDINGS DO NOT RESULT IN THE REMOVAL OF WALL AND CEILING FINISHES AND THERE IS NO ACCESS BY MEANS OF ATTIC, BASEMENT OR CRAWL SPACE. (CRC 314.4 AND §314.6)

VENTILATION REQUIREMENTS:


- TERMINATION OF ALL ENVIRONMENTAL AIR DUCTS SHALL BE AT LEAST 3 FEET FROM PROPERTY LINE AND FROM OPENINGS INTO THE BUILDING, AND 10 FEET FROM A FORCED AIR INLET. (CMC 502.2.1)
- WHOLE-BUILDING VENTILATION: KITCHENS REQUIRE VENTILATION AIR FLOW AT 100 CUBIC FEET PER MINUTE OR MORE FOR INTERMEDIATE SYSTEMS OR 5 AIR CHANGES PER HOUR FOR CONTINUOUS SYSTEMS. (ASHRAE 62.2)

WINDOW MODIFICATIONS: REPLACEMENT AND NEW WINDOWS:

1. SHALL HAVE A U-FACTOR EQUAL TO 0.30 OR LOWER. EXCEPTIONS:
REPLACEMENT SKYLIGHTS, OR NEW SKYLIGHTS UP TO 16 SQUARE FEET, MAY HAVE A U-FACTOR OF 0.35, WHEN 75 SQUARE FEET OR LESS OF PENETRATION IS REPLACED WINDOWS MAY HAVE A U-FACTOR OF 0.40. (CEMC 150.0(B) TABLE 150.1-A)
2. FOR WINDOW MODIFICATIONS IN THE HILLSIDE FIRES ZONES 2 AND 3 REFER TO WINDOW AND DOOR CODE COMPLIANCE CHECKLIST

BUILDING ENVELOPE MODIFICATIONS:


EXTERIOR WALL, FLOOR AND ROOF FRAMING SPACES OPENED UP DURING THE COURSE OF REMODEL SHALL BE INSULATED. R-13 (2X4 WALL), R-20 (2X6 WALL), R-19 (FLOOR), AND R-19 (ATTIC/ROOF) INSULATION. (CEMC 150.0(A)(C)(D))

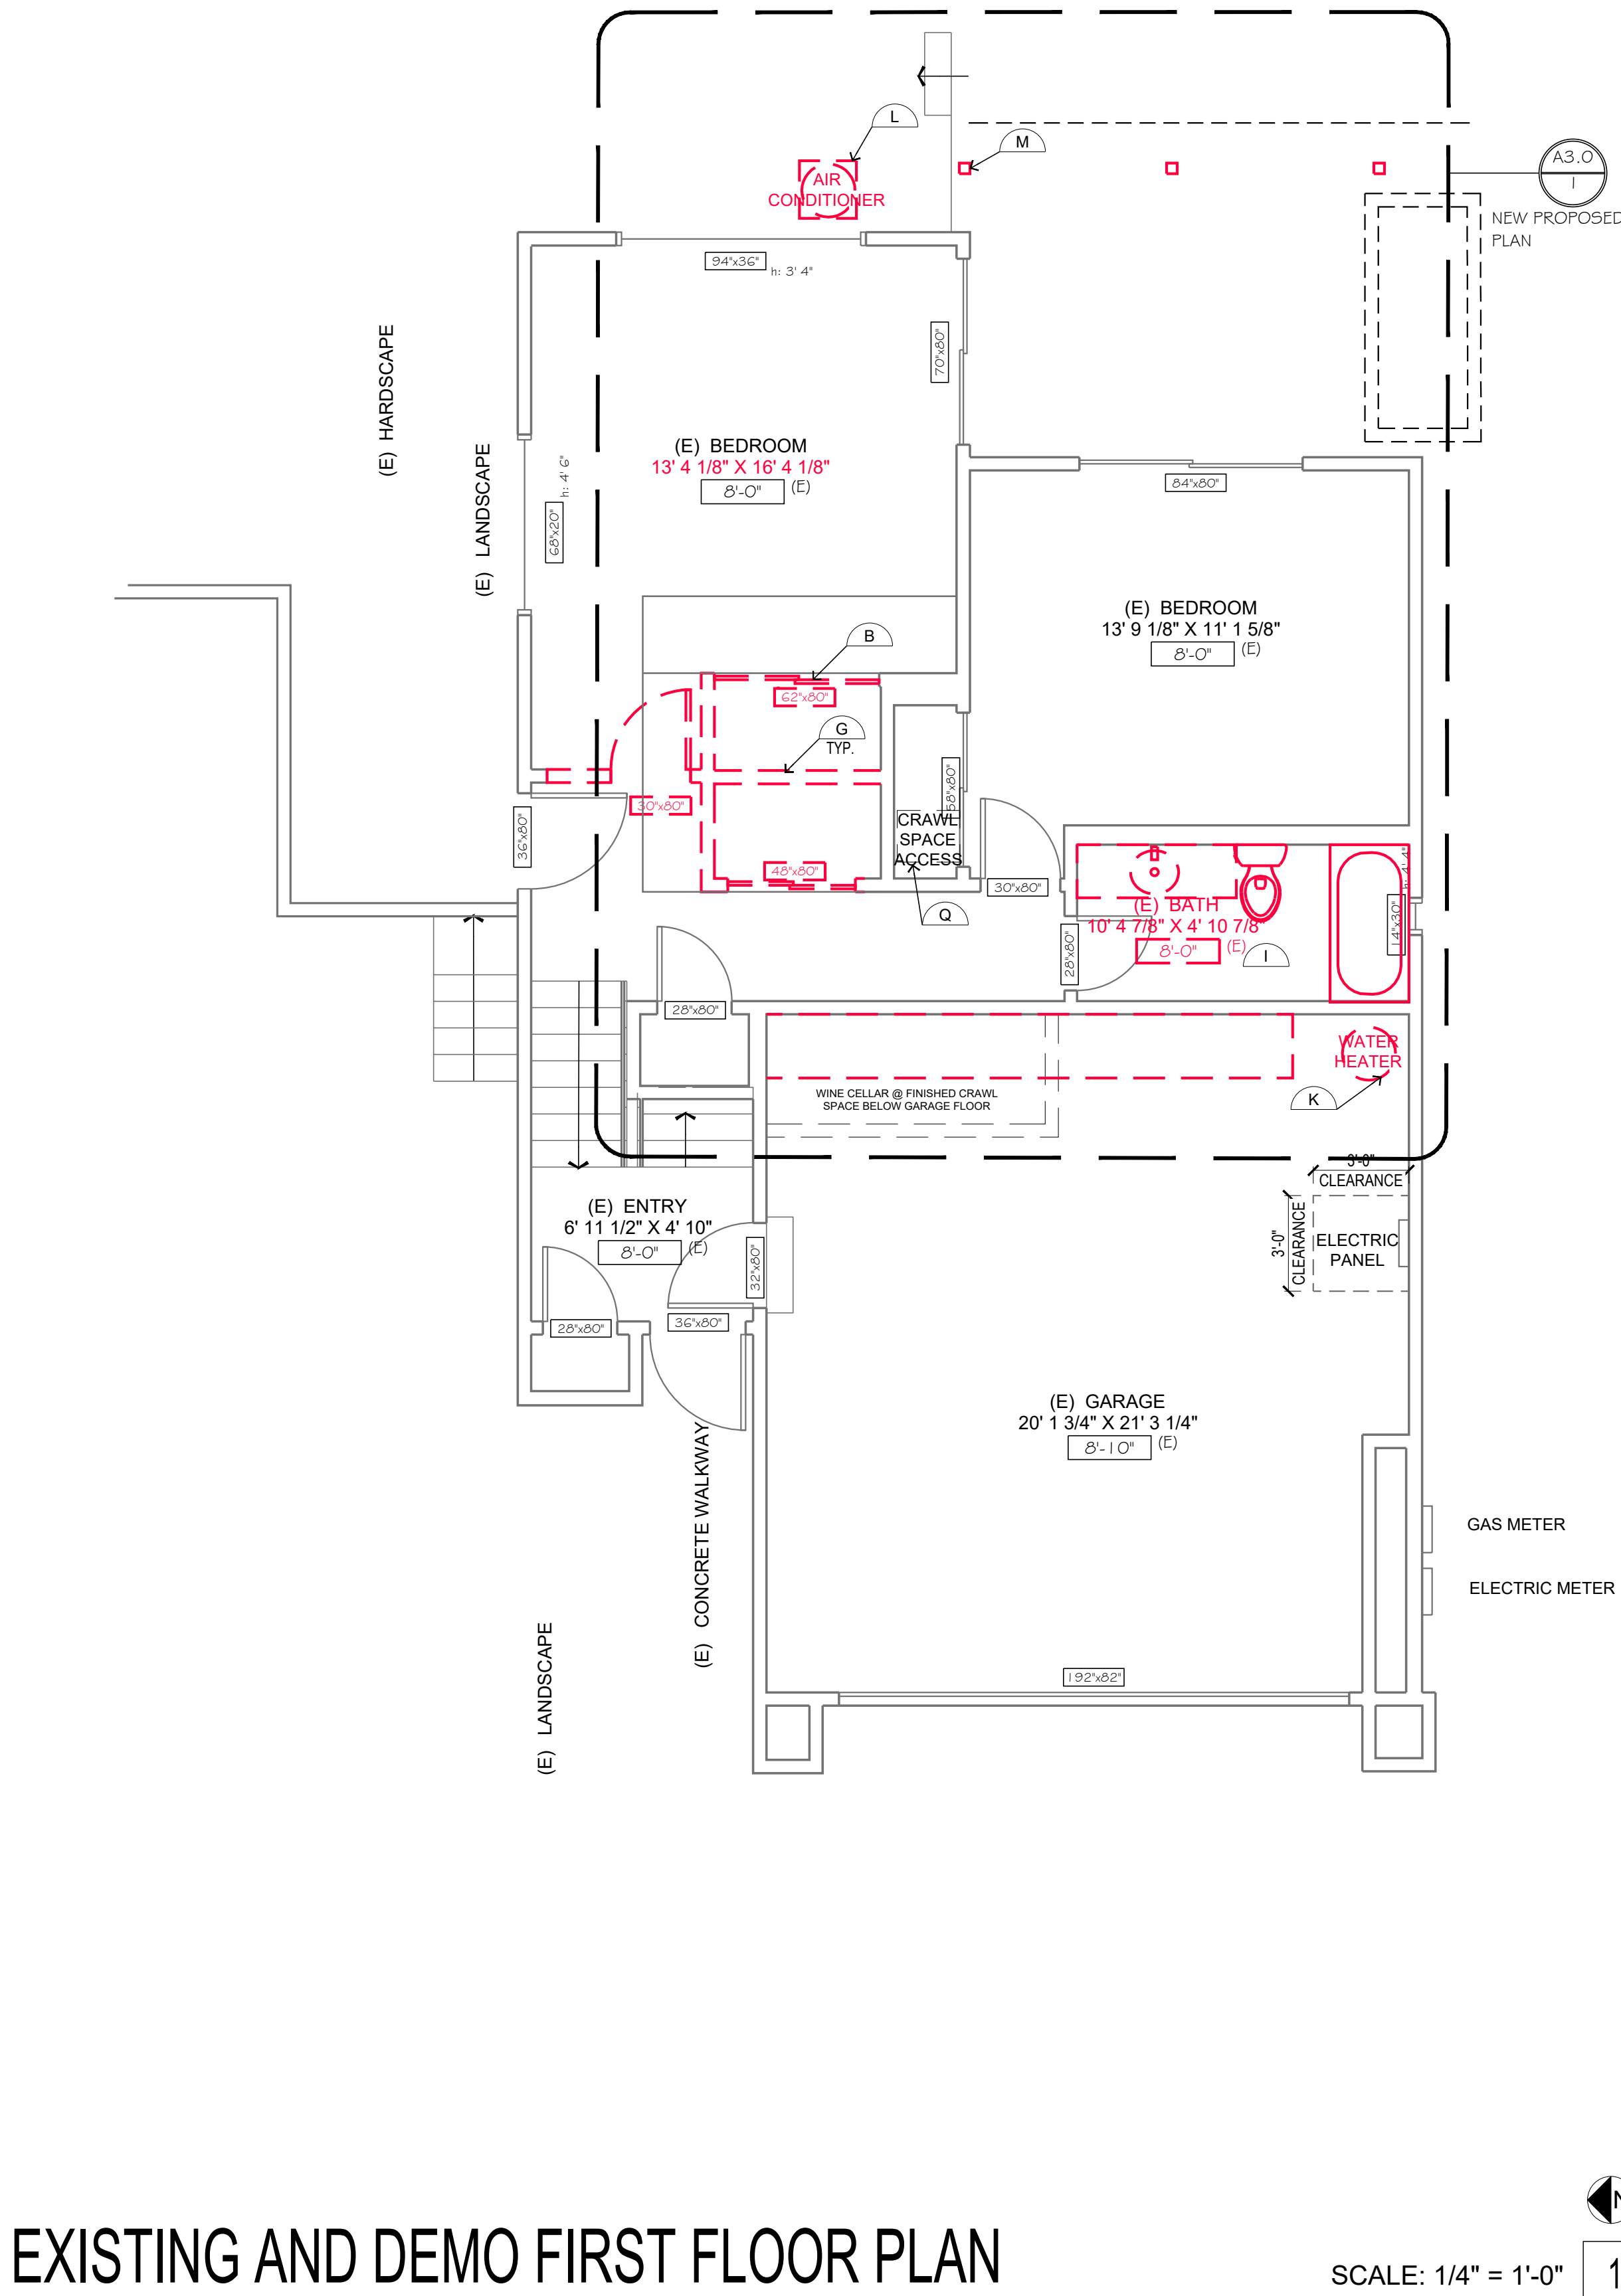

EXISTING AND DEMO FIRST FLOOR PLAN

SCALE: 1/4" = 1'-0"

1

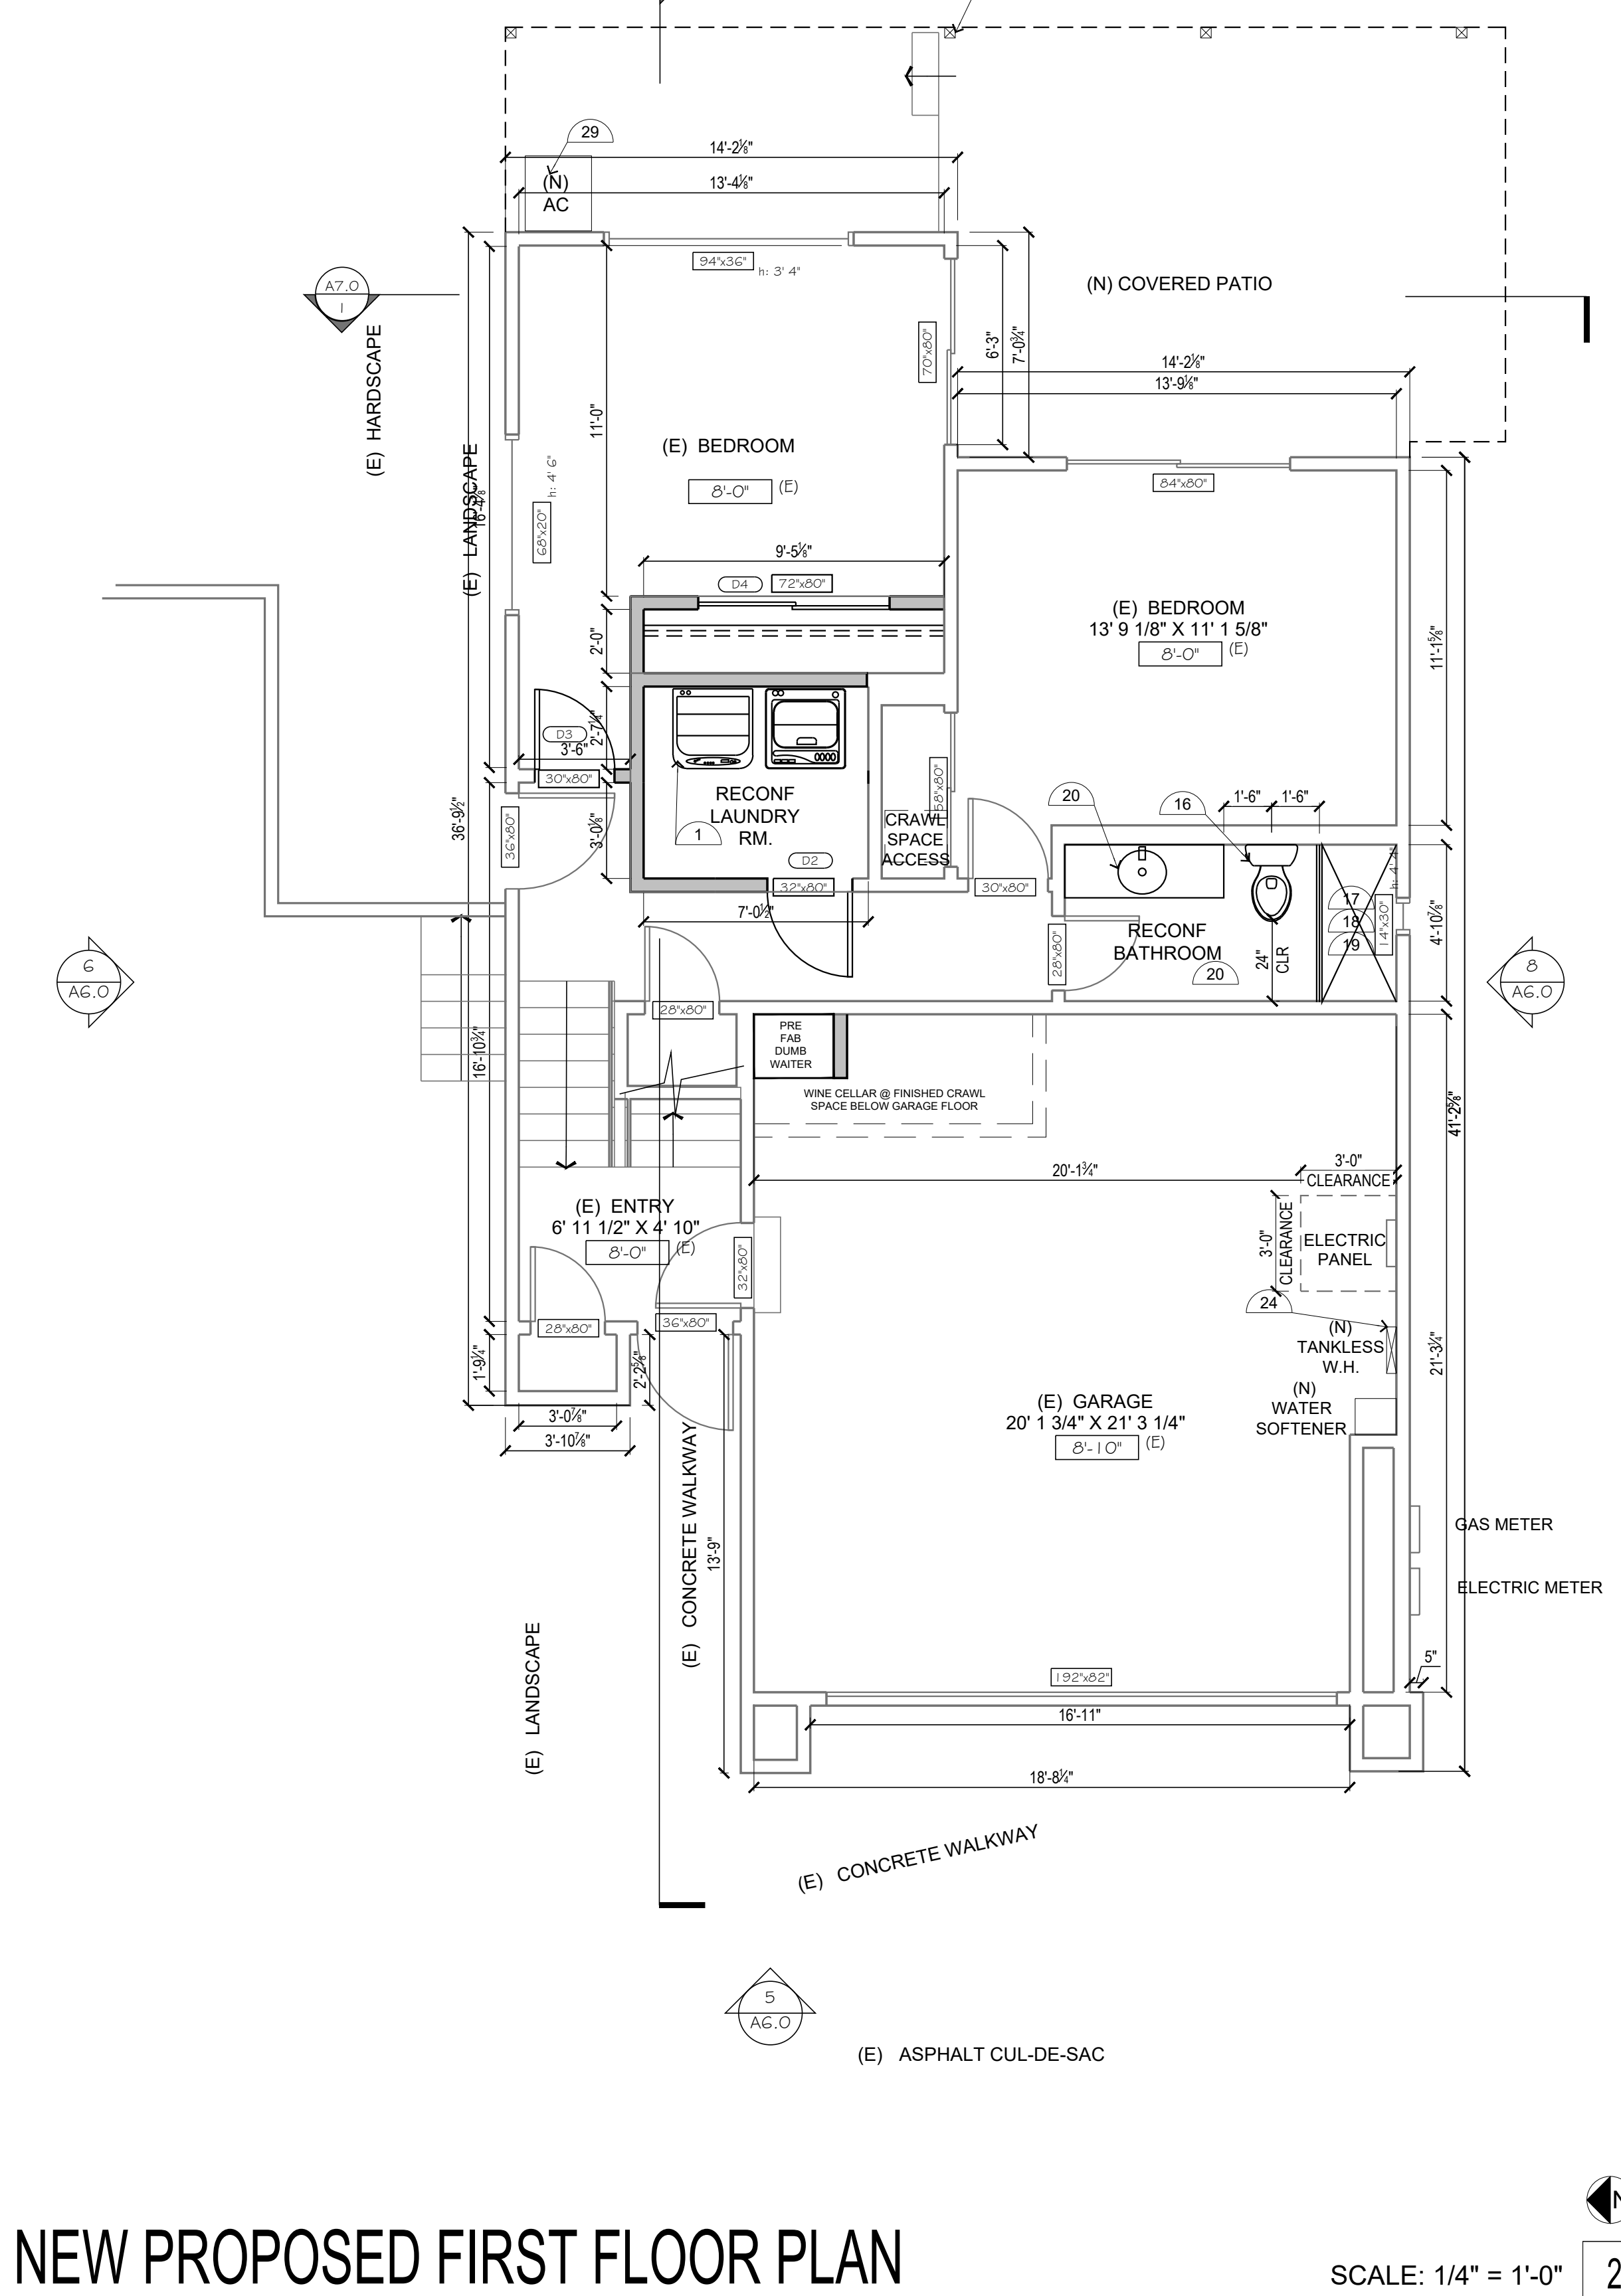

NEW PROPOSED FIRST FLOOR PLAN

SCALE: 1/4" = 1'-0"

2



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Los Gatos, CA 95032

description date

1 planning comments response 6.9.2025

2 planning comments resp. 6.19.2025

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- demo sheet notes**
- A. REMOVE EXISTING DOORS (SHOWN DASHED).
B. REMOVE EXISTING DOOR (SHOWN DASHED). INFILL WITH NEW WALL AND MATCH TO ALIGN WITH EXISTING ADJACENT.
C. REMOVE EXISTING DOOR (SHOWN DASHED). REPLACE WITH NEW DOOR.
D. REMOVE EXISTING WINDOW (SHOWN DASHED).
E. REMOVE EXISTING WINDOWS (SHOWN DASHED). REPLACE WITH NEW DOOR.
F. REMOVE EXISTING WINDOWS (SHOWN DASHED). FILLED WITH NEW WALL.
G. REMOVE THIS PORTION OF EXISTING WALL.
H. REMOVE (E) KITCHEN UPPER & LOWER CABINET, COUNTERTOP, FAUCET, STOVE, REFRIGERATOR, DISHWASHER, DISPOSAL, & OVEN, CAP & SALVAGE (E) PLUMBING & GAS LINE FOR NEW APPLIANCES. SEE PROPOSED FLOOR PLAN FOR NEW LOCATION.
I. REMOVE PLUMBING FITTURE AND ACCESSORIES. CAP PLUMBING LINES BEHIND WALLS/UNDER FLOOR.
J. REMOVE ATTIC ACCESS (SHOWN DASHED).
K. REMOVE WATER HEATER (SHOWN DASHED).
L. REMOVE AIR CONDITIONER.
M. REMOVE EXISTING POST. SEE S.S.D.
N. REMOVE EXISTING STEP.
O. REMOVE DECK (SHOWN DASHED).
P. (E) SKYLIGHT TO REMAIN.
Q. (E) DRAIN. SPACE ACCESS TO REMAIN.

- new sheet notes**
1. NEW RELOCATED WASHER. PROVIDE POWER.
2. PROVIDE WATER HAMMER ARRESTORS AT ALL APPLIANCES THAT HAVE QUICK-ACTING VALVES (I.E. DISHWASHER HOT WATER LINE AND THE HOT/COLD WATER LINES FOR THE CLOTHES WASHER.) 2022CPC 609.10
3. PROVIDE NEW DISHWASHER. PROVIDE POWER AND PLUMBING. ON THE DISHWASHER SIDE OF THE DISHWASHER PROVIDE A LISTED AIR GAP FITTING. LISTED AIR GAPS SHALL BE INSTALLED WITH THE FLOOD LEVEL WARNING AT OR ABOVE THE FLOOD LEVEL OF THE SINK OR DRAIN BOARD WHICHEVER IS HIGHER PER CPC SECTION 807.3.
4. INSTALLATION OF A DEDICATED FUEL SHUT OFF VALVE SHALL BE WITHIN 6'-0" OF THE GAS APPLIANCE IT SERVES. CPC 230.79. EARTHQUAKE-ACTUATED GAS SHUTOFF VALVES DESIGNED TO AUTOMATICALLY SHUT OFF THE GAS AT THE LOCATION OF THE VALVE IN THE EVENT OF A SEISMIC DISTURBANCE AND CERTIFIED BY THE STATED ARCHITECT AS CONFORMING TO CALIFORNIA CODE OF REGULATIONS, TITLE 24, PART 12, CHAPTER 12.06.01. SHALL BE INSTALLED IN ALL NEW BUILDINGS AND IN EXISTING BUILDINGS THAT UNDERGO ALTERATIONS OR ADDITIONS THAT EXCEED \$10,000.
5. PROVIDE NEW GAS COOKING RANGE (PROVIDE POWER) WITH NEW EXHAUST HOOD (PROVIDE POWER) WITH A MIN. VENTILATION EXHAUST RATE OF 100 CFM. HOUSEHOLD COOKING APPLIANCES SHALL HAVE A VERTICAL CLEARANCE ABOVE THE COOKING TOP OF NOT LESS THAN THIRTY - 30" INCHES TO COMBUSTIBLE MATERIAL OR METAL CABINETS. EXCEPT WHERE 24 INCHES IS ALLOWED PER CODE OR MANUFACTURER'S SPECIFICATION. CMC 920.3.2.
6. RANGE HOODS SHALL BE PERMITTED TO BE CORD-AND-PLUG-CONNECTED WITH A FLEXIBLE CORD IDENTIFIED AS SUITABLE FOR USE ON RANGE HOODS IN THE INSTALLATION INSTRUCTIONS OF THE APPLIANCE MANUFACTURER. WHERE ALL THE FOLLOWING CONDITIONS ARE MET: THE FLEXIBLE CORD IS TERMINATED WITH A GROUNDING-TYPE ATTACHMENT PLUS; THE LENGTH OF THE CORD IS 18 INCHES TO 4 FEET; RECEPTACLES ARE LOCATED TO PROTECT AGAINST PHYSICAL DAMAGE TO THE FLEXIBLE CORD; THE RECEPTACLES IS ACCESSIBLE. THE RECEPTACLE IS SUPPLIED BY AN INDIVIDUAL BRANCH CIRCUIT.
7. IF OCCURS ELECTRIC STOVES AND OVENS SHALL BE SUPPLIED WITH 40- OR 50-AMP BRANCH CIRCUIT.
8. PROVIDE NEW SINK WITH CALGREEN COMPLIANT FAUCET WITH NEW GARBAGE DISPOSAL (PROVIDE POWER).
9. NEW REFRIGERATOR/ICE MAKER/WINE COOLER (PROVIDE POWER AND ICE MAKER OUTLET BOX AND CONNECT).
10. NEW SOLID COUNTER TOP WITH UPPER AND LOWER CABINETS.
11. COUNTERTOP AND WHERE THE COUNTERTOP DOES NOT EXTEND MORE THAN 6 INCHES BEYOND ITS BASE.
12. NEW SOLID SURFACE COUNTER KITCHEN ISLAND AND BAR COUNTER WITH BASE CABINET.
13. COMBINATION TYPE ARC-FAULT CIRCUIT INTERRUPTER SHALL PROTECT ALL RECEPTACLES IN ALL BEDROOMS, LIVING ROOMS, DINING ROOMS, PARLORS, LIBRARIES, DEN'S, SUNROOMS, RECREATION ROOMS, CLOSETS, KITCHENS, LAUNDRY AREAS, HALLWAYS OR SIMILAR ROOMS OR AREAS WITH BRANCH CIRCUITS THAT SUPPLY 125 VOLT, SINGLE-PHASE, 15 AND 20-AMPERE RECEPTACLE OUTLETS, AND BE READILY ACCESSIBLE. 2022 CEC SECTION 210.12
14. TWO 20-AMP GFCI PROTECTED CIRCUITS WILL BE PROVIDED IN THE KITCHEN COUNTER AND ISLAND OUTLETS AND SHALL COMPLY WITH ART. 210.52 (C) (5) EXCEPTION TO (5) CEC 2022
15. LIGHTING INTEGRAL TO EXHAUST FANS SHALL BE CONTROLLED SEPARATELY FROM THE EXHAUST FANS. 150.0 (K) 28.
16. LIGHTING SHALL HAVE VACUUM SENSOR. EXHAUST FAN SHALL BE 50 CFM MIN.
17. PROVIDE WATER CLOSETS TO BE MAX. 1.28 GAL. PER FLUSH.
18. SHOWER/TUB W/ FULL HEIGHT TILE WALLS & TEMPERED GLASS ENCLOSURE. USE BUTYLMAE 4,000 WATERPROOFING MEMBRANE OVER 1/2" WONDER BOARD & WALLS, CEILING, & FLOOR.
19. NEW SOLID SURFACE (NON-SLIP RESISTANT) SHOWER PAN AND WALLS.
20. PROVIDE SHOWER FINISHED TO 72" ABOVE DRAIN. PROVIDE PRESSURE OR THERMOSTATIC MIXING VALVE @ SHOWER AND JACUZZI/TUB, WHICH LIMITS WATER TEMPERATURE TO 120°F. SHOWER HEAD SHALL NOT EXCEED 1.8 GALLONS PER MINUTE AT 80 PSI.
21. NEW SINK AND FAUCET. PROVIDE FAUCET TO BE MAX 1.2 GPM AT 60 PSI. METERING FAUCETS SHALL NOT EXCEED 0.2 GALLONS PER METERING CYCLE.
22. WINDOW MODIFICATIONS: REPLACEMENT AND NEW WINDOWS: SHALL HAVE A U-FACTOR EQUAL TO 0.30
23. PROVIDE NEW COMBO UNIT SMOKE DETECTOR AND CARBON MONOXIDE DETECTOR W/BATTERY BACK-UP IN HALLWAY.
24. PROVIDE NEW 24" X 48" FLAT PROFILE SKYLIGHT.
25. PROVIDE NEW TANKLESS WATER HEATER.
26. NEW MIN. 36"x24" ATTIC ACCESS.
27. NEW PREFABRICATED STAIRS (NOT USE)
28. NEW P.1. POSTS ON CONC. BASE 2" ABOVE FINISHED GRADE (TYP.)
29. NEW DECKING OVER FRAMING. S.S.D. FOR FRAMING DETAILS.
30. NEW AIR CONDITIONER.

- KITCHEN GENERAL NOTES (2022 CBC REQUIREMENTS):**
- WATER CONSERVING PLUMBING FIXTURES REQUIREMENTS:
• KITCHEN FAUCETS SHALL HAVE A MAXIMUM FLOW RATE OF 1.8 GALLONS PER MINUTE. FLOW MAY TEMPORARILY INCREASE TO 2.2 GALLONS PER MINUTE, BUT MUST DEFAULT TO A MAXIMUM OF 1.8 GALLONS PER MINUTE. [CGBSC 4.303.1.4.4]
• PRIOR TO FINAL INSPECTION ALL NON-COMPLIANT PLUMBING FIXTURES SHALL BE UPGRADED WITH WATER-CONSERVING FIXTURES AS REQUIRED BY CIVIL CODE 1101.1. A COMPLETED AND SIGNED CERTIFICATE OF COMPLIANCE SHALL BE PROVIDED TO THE BUILDING INSPECTOR.
ELECTRICAL REQUIREMENTS:
• RECEPTACLE OUTLETS SHALL BE INSTALLED SO THAT NO POINT ALONG THE WALL COUNTERTOP OR WORK SURFACE IS MORE THAN 24 INCHES FROM A RECEPTACLE IN THAT SPACE. [CEC 210.52(C)(1)]
• RECEPTACLE OUTLETS SHALL BE INSTALLED AT EACH KITCHEN COUNTERTOP AND WORK SURFACE THAT IS 12 INCHES OR WIDER. [CEC 210.52(C)(1)]
• AT LEAST ONE RECEPTACLE OUTLET SHALL BE INSTALLED AT EACH ISLAND OR PENINSULAR COUNTER SPACE WITH A LONG DIMENSION OF 24 INCHES OR GREATER AND A SHORT DIMENSION OF 12 INCHES OR GREATER. [CEC 210-52(C)(2) AND 210.52(C)(3)]
• ALL ELECTRICAL OUTLETS SERVING KITCHEN COUNTERTOPS AND DISHWASHERS SHALL BE GFCI PROTECTED. GROUND FAULT CIRCUIT INTERRUPTERS SHALL BE LOCATED IN A READILY ACCESSIBLE LOCATION. [CEC 210.8(A)(D)]
• AT LEAST TWO SEPARATE 20-AMPERE BRANCH CIRCUITS SHALL BE PROVIDED FOR SMALL KITCHEN APPLIANCES. THESE CIRCUITS ARE LIMITED TO SUPPLYING WALL AND COUNTER SPACE OUTLETS ONLY AND CANNOT SERVE DISHWASHER, MICROWAVE, RANGE HOOD, GARBAGE DISPOSAL, ETC. [CEC 210.11(C)(1) AND 210.52(B)(3)]
• ALL ADDED/REPLACED RECEPTACLES SHALL BE LISTED TAMPER-RESISTANT RECEPTACLES AND SHALL BE ARC FAULT PROTECTED. [CEC 406.12]

- 2022 BATHROOM REMODEL REQUIREMENTS:**
1. PROVIDE WATERPROOFED MATERIAL AT SHOWER WALLS.
2. ALL RECEPTACLES SHALL BE GFCI PROTECTED AND CONNECTED TO A DEDICATED 15 AND 20 AMPS CIRCUIT - ASCE 210.8.4
3. ALL HARDWIRED LIGHTING SHALL BE HIGH EFFICACY. - ICA ENERGY EFF. STANDARDS, SECTION 1500(K)
4. EXHAUST FANS ARE REQUIRED IN ALL BATHROOMS, EVEN IF AN OPERABLE WINDOW IS INSTALLED. CPC 303.35
5. EXHAUST FANS AND LIGHTING SHALL HAVE SEPARATE CONTROL SWITCHES, (EVEN IF A COMBINATION UNIT IS INSTALLED). THE EXHAUST FAN MAY NEED TO BE SUPPLIED BY A GFCI PROTECTED CIRCUIT BASED ON THE MANUFACTURER'S REQUIREMENTS. CEC 150.0 (K)(28)
6. EXHAUST FANS SHALL TERMINATE A MINIMUM OF 3' FROM PROPERTY LINE AND 3' FROM OPENINGS INTO A BUILDING. (CMC 502.2.1)
7. EXHAUST FANS AT SHOWER SHALL BE LISTED FOR WET LOCATION AND SHALL BE GFCI PROTECTED. CEC 210.8
8. SHOWER ENCLOSURE DOORS SHALL OPEN OUTWARD AND MAINTAIN 22" H. CLEARANCE. CPC 408.5
9. SHOWER COMPARTMENT SHALL BE A MINIMUM 1,024 SQUARE INCHES ENCOMPASSING A 30" H. CIRCLE. CPC 408.6
10. WATER CLOSETS (MAXIMUM 1.28 GPM. & SHALL BE CLEAR 30 INCHES WIDE 15 INCHES ON CENTER) AND 24 INCHES IN FRONT. CPC 402.5
11. SHOWER HEADS (MAXIMUM 1.8 GPM CPC 408.2 & FAUCETS (MAXIMUM 1.2 GPM CPC 407.2)
12. BATHTUBS/WHIRLPOOLS AND SHOWER VALVES SHALL BE APPROVED PRESSURE-BALANCED OR THERMOSTATIC MIXING TYPE ADJUSTED TO A MINIMUM OF 120 DEGREES. CPC 409.3

- legend**
- (E) STUD WALL TO REMAIN
(E) WALL, DOORS AND WINDOWS TO REMOVE
(N) 2x STUD WALL
EXTERIOR WALL TO RECEIVE 2X6 WITH R-13 BATT. INSULATION
SEE TITLE 24 FOR MORE INFO.
EXTERIOR ELEVATION REFERENCE TAG
DETAIL NUMBER
SHEET NUMBER

- DEMOLISHED WALL AREA: 750.67 sq
- NEW WALL AREA: 514.5 sq

- LIGHTING REQUIREMENTS:**
- ALL INSTALLED LUMINAIRES SHALL BE HIGH EFFICACY. [CECNC 150.0 TABLE 150.0-A]
 - UNDER CABINET LIGHTING SHALL BE CONTROLLED SEPARATELY FROM CEILING INSTALLED LIGHTING SUCH THAT ONE CAN BE TURNED ON WITHOUT THE OTHER. [CECNC 150.0(2)(K)]
 - LUMINAIRES RECESSED INTO INSULATED CEILINGS:
(A) SHALL BE LISTED FOR ZERO CLEARANCE INSULATION COVER (IC RATED);
(B) SHALL INCLUDE A LABEL CERTIFYING AIR TIGHT (AT) WITH AIR LEAKAGE LESS THAN 2.0 CFM AT 75 PASCALS.
(C) SHALL BE SEALED WITH A GASKET OR CAULK BETWEEN THE LUMINARY HOUSING AND CEILING;
(D) IF RECESSED LIGHTS ARE EQUIPPED WITH BALLASTS, SHALL ALLOW BALLAST MAINTENANCE AND REPLACEMENT WITHOUT REQUIRING CUTTING OF HOLES IN THE CEILING; AND
(E) SHALL NOT CONTAIN SCREW BASE SOCKETS. [CECS SEC.150(K)(2)]

- SMOKE AND CARBON MONOXIDE DETECTOR**
WHEN ALTERATIONS REPAIRS OR ADDITIONS REQUIRING A PERMIT OCCUR, THE INDIVIDUAL DWELLING UNIT SHALL BE EQUIPPED WITH SMOKE ALARMS LOCATED AS REQUIRED FOR NEW DWELLINGS. [R314.2.2]

- SMOKE ALARMS:** DWELLINGS ARE TO BE EQUIPPED WITH SMOKE ALARMS INSTALLED IN THE FOLLOWING LOCATIONS: [CRC 314.4]
- IN EACH EXISTING SLEEPING ROOM.
 - OUTSIDE EACH SEPARATE SLEEPING AREA IN THE IMMEDIATE VICINITY OF THE BEDROOMS.
 - ON EACH STORY INCLUDING BASEMENTS AND HABITABLE ATTICS, NOT INCLUDING CRAWL SPACES AND UNINHABITABLE ATTICS.
 - INSTALLED NOT LESS THAN 3 FEET HORIZONTALLY FROM THE DOOR OR OPENING OF A BATHROOM THAT CONTAINS A BATHTUB OR SHOWER UNLESS THIS WOULD PREVENT PLACEMENT OF A SMOKE ALARM REQUIRED BY CRC R314.3(4).
- CARBON MONOXIDE ALARMS:** DWELLINGS THAT HAVE ATTACHED GARAGES WITH AN OPENING THAT COMMUNICATES WITH THE DWELLING UNIT, OR FUEL BURNING APPLIANCES, OR FIRE PLACE ARE TO BE EQUIPPED WITH CARBON MONOXIDE ALARMS INSTALLED IN THE FOLLOWING LOCATIONS: [CRC 315.3]
- OUTSIDE EACH SEPARATE SLEEPING AREA IN THE IMMEDIATE VICINITY OF THE BEDROOMS.
 - ON EVERY OCCUPABLE LEVEL OF A DWELLING UNIT INCLUDING BASEMENTS.
 - WHERE A FUEL-BURNING APPLIANCE IS LOCATED WITHIN A BEDROOM OR ITS ATTACHED BATHROOM, A CARBON MONOXIDE ALARM SHALL BE INSTALLED WITHIN THE BEDROOM.
- ALARM INTERCONNECTION AND POWER:** SMOKE AND CARBON MONOXIDE ALARMS ARE REQUIRED TO BE INTERCONNECTED SUCH THAT ACTIVATION OF ONE ALARM WILL ACTIVATE ALL OF THE ALARMS AND SHALL RECEIVE THEIR PRIMARY POWER FROM THE BUILDING WIRING. EXCEPTION: WHERE REPAIRS OR ALTERATIONS TO EXISTING BUILDINGS DO NOT RESULT IN THE REMOVAL OF WALL AND CEILING FINISHES AND THERE IS NO ACCESS BY MEANS OF ATTIC, BASEMENT OR CRAWL SPACE. [CRC 314.4 AND 3314.6]

- VENTILATION REQUIREMENTS:**
- TERMINATION OF ALL ENVIRONMENTAL AIR DUCTS SHALL BE AT LEAST 3 FEET FROM PROPERTY LINE AND FROM OPENINGS INTO THE BUILDING, AND 10 FEET FROM A FORCED AIR INLET. [CMC 502.2.1]
 - WHOLE-BUILDING VENTILATION: KITCHENS REQUIRE VENTILATION AIR FLOW AT 100 CUBIC FEET PER MINUTE OR MORE FOR INTERMEDIATE SYSTEMS OR 5 AIR CHANGES PER HOUR FOR CONTINUOUS SYSTEMS. [ASHRAE 62.2]
- WINDOW MODIFICATIONS: REPLACEMENT AND NEW WINDOWS:**
1. SHALL HAVE A U-FACTOR EQUAL TO 0.30 OR LOWER. EXCEPTIONS:
REPLACEMENT SKYLIGHTS, OR NEW SKYLIGHTS UP TO 16 SQUARE FEET, MAY HAVE A U-FACTOR OF 0.35, WHEN 7.5 SQUARE FEET OR LESS OF FENESTRATION IS REPLACED WINDOWS MAY HAVE A U-FACTOR OF 0.40. [CECNC 150.0(2)(B) TABLE 150.1-A]
FOR WINDOW MODIFICATIONS IN THE HILLSIDE FIRES ZONES 2 AND 3 REFER TO WINDOW AND DOOR CODE COMPLIANCE CHECKLIST
2. BUILDING ENVELOPE MODIFICATIONS:
EXTERIOR WALL, FLOOR AND ROOF FRAMING SPACES OPENED UP DURING THE COURSE OF REMODEL SHALL BE INSULATED. R-13 [2X4 WALL], R-20 [2X6 WALL], R-19 (FLOOR), AND R-19 [ATTIC/ROOF] INSULATION. [CECNC 150.0(A)(C)(D)]



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revision history	date	
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<input type="radio"/> bidding		
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date 4.19.2024

proj num

proj mgr

proj arch

scale AS NOTED

EXISTING AND DEMO AND NEW
PROPOSED SECOND FLOOR
PLANS

sheet number
A2.0

EXISTING AND DEMO SECOND FLOOR PLAN

SCALE: 1/4" = 1'-0"

NEW PROPOSED SECOND FLOOR PLAN

SCALE: 1/4" = 1'-0"

DISCLAIMER: THIS DOCUMENT IS PROVIDED AND INTENDED TO BE USED AS A MEANS TO INDICATE AREAS OF COMPLIANCE WITH THE CALIFORNIA GREEN BUILDING STANDARDS (CALGREEN) CODE. DUE TO THE VARIABLES BETWEEN BUILDING DEPARTMENT JURISDICTIONS, THIS CHECKLIST IS TO BE USED ON AN INDIVIDUAL PROJECT BASIS AND MAY BE MODIFIED BY THE END USER TO MEET THOSE INDIVIDUAL NEEDS. THE END USER ASSUMES ALL RESPONSIBILITY ASSOCIATED WITH THE USE OF THIS DOCUMENT, INCLUDING VERIFICATION WITH THE FULL CODE.

demo sheet notes

- A. REMOVE EXISTING DOORS (SHOWN DASHED).
B. REMOVE EXISTING DOOR (SHOWN DASHED), INFILL WITH NEW WALL AND MATCH TO ALIGN WITH EXISTING ADJACENT.
C. REMOVE EXISTING DOOR (SHOWN DASHED), REPLACE WITH NEW DOOR.
D. REMOVE EXISTING WINDOW (SHOWN DASHED).
E. REMOVE EXISTING WINDOWS (SHOWN DASHED), REPLACE WITH NEW DOOR.
F. REMOVE EXISTING WINDOWS (SHOWN DASHED), FILLED WITH NEW WALL.
G. REMOVE THIS PORTION OF EXISTING WALL.
H. REMOVE (E) KITCHEN UPPER & LOWER CABINET, COUNTERTOP, FAUCET, STOVE, REFRIGERATOR, DISHWASHER, DISPOSAL, & OVEN, CAP & SALVAGE (E) PLUMBING & GAS LINE FOR NEW APPLIANCES, SEE PROPOSED FLOOR PLAN FOR NEW LOCATION.
I. REMOVE PLUMBING FIXTURE AND ACCESSORIES, CAP PLUMBING LINES BEHIND WALLS/UNDER FLOOR.
J. REMOVE ATTIC ACCESS (SHOWN DASHED).
K. REMOVE WATER HEATER (SHOWN DASHED).
L. REMOVE AIR CONDITIONER.
M. REMOVE EXISTING POST, SEE S.S.D.
N. REMOVE EXISTING STEP.
O. REMOVE DECK (SHOWN DASHED).
P. (E) SKYLIGHT TO REMAIN.
Q. (E) CRAWL SPACE ACCESS TO REMAIN.

new sheet notes

1. NEW RELOCATED WASH. PROVIDE POWER.
2. PROVIDE WATER HAMMER ARRESTORS AT ALL APPLIANCES THAT HAVE QUICK-ACTING VALVES (I.E. DISHWASHER HOT WATER LINE AND THE HOT/COLD WATER LINES FOR THE CLOTHES WASHER.) 2022CPC 609.10
3. PROVIDE NEW DISHWASHER, PROVIDE POWER AND PLUMBING, ON THE DISHWASHER SIDE OF THE DISHWASHER PROVIDE A LISTED AIR GAP FITTING. LISTED AIR GAPS SHALL BE INSTALLED WITH THE FLOOD LEVEL MARKING AT OR ABOVE THE FLOOD LEVEL OF THE SINK OR DRAIN BOARD WHICHEVER IS HIGHER PER CPC SECTION 807.3.
4. INSTALLATION OF A DEDICATED FUEL SHUT OFF VALVE SHALL BE WITHIN 6'-0" OF THE GAS APPLIANCE IT SERVES. CPC 230.79. EARTHQUAKE-ACTUATED GAS SHUTOFF VALVES DESIGNED TO AUTOMATICALLY SHUT OFF THE GAS AT THE LOCATION OF THE VALVE IN THE EVENT OF A SEISMIC DISTURBANCE AND CERTIFIED BY THE STATED ARCHITECT AS CONFORMING TO CALIFORNIA CODE OF REGULATIONS, TITLE 24, PART 12, CHAPTER 12.410.471, SHALL BE INSTALLED IN ALL NEW BUILDINGS AND IN EXISTING BUILDINGS THAT UNDERGO ALTERATIONS OR ADDITIONS THAT EXCEED \$10,000.
5. PROVIDE NEW GAS COOKING RANCE (PROVIDE POWER) WITH NEW EXHAUST HOOD (PROVIDE POWER) WITH A MIN. VENTILATION EXHAUST RATE OF 100 CFM. HOUSEHOLD COOKING APPLIANCES SHALL HAVE A VERTICAL CLEARANCE ABOVE THE COOKING TOP OF NOT LESS THAN THIRTY - 30" INCHES TO COMBUSTIBLE MATERIAL OR METAL CABINETS, EXCEPT WHERE 24 INCHES IS ALLOWED PER CODE OR MANUFACTURER'S SPECIFICATION. CMC 920.12.
6. RANGE HOODS SHALL BE PERMITTED TO BE CORD-AND-PLUG-CONNECTED WITH A FLEXIBLE CORD IDENTIFIED AS SUITABLE FOR USE ON RANGE HOODS IN THE INSTALLATION INSTRUCTIONS OF THE APPLIANCE MANUFACTURER, WHERE ALL THE FOLLOWING CONDITIONS ARE MET: THE FLEXIBLE CORD IS TERMINATED WITH A GROUNDING-TYPE ATTACHMENT PLUG; THE LENGTH OF THE CORD IS 18 INCHES TO 4 FEET; RECEPTACLES ARE LOCATED TO PROTECT AGAINST PHYSICAL DAMAGE TO THE FLEXIBLE CORD; THE RECEPTACLES IS ACCESSIBLE. THE RECEPTACLE IS SUPPLIED BY AN INDIVIDUAL BRANCH CIRCUIT.
7. IF OCCURS ELECTRIC STOVES AND OVENS SHALL BE SUPPLIED WITH 40- OR 50-AMP BRANCH CIRCUIT.
8. PROVIDE NEW SINK WITH CALGREEN COMPLIANT FAUCET WITH NEW GARBAGE DISPOSAL (PROVIDE POWER).
9. NEW REFRIGERATOR/ICE MAKER/WINE COOLER (PROVIDE POWER AND ICE MAKER OUTLET BOX AND CONNECT).
10. NEW SOLID COUNTER TOP WITH UPPER AND LOWER CABINETS.
11. COUNTERTOP AND BASES THE COUNTERTOP DOES NOT EXTEND MORE THAN 6 INCHES BEYOND ITS BASE.
12. NEW SOLID SURFACE COUNTER KITCHEN ISLAND AND BAR COUNTER WITH BASE CABINET.
13. COMBINATION TYPE ARC-FAULT CIRCUIT INTERRUPTER SHALL PROTECT ALL RECEPTACLES IN ALL BEDROOMS, DINING ROOMS, LIVING ROOMS, PARLOES, LIBRARIES, DENIS SUNROOMS, RECREATION ROOMS, CLOSETS, KITCHENS, LAUNDRY AREAS, HALLWAYS OR SIMILAR ROOMS OR AREAS WITH BRANCH CIRCUITS THAT SUPPLY 125 VOLT, SINGLE-PHASE, 15 AND 20-AMPERE RECEPTACLE OUTLETS, AND BE READILY ACCESSIBLE. 2022 CEC SECTION 210.12
14. TWO 20-AMP GFCI PROTECTED CIRCUITS WILL BE PROVIDED IN THE KITCHEN COUNTER AND ISLAND OUTLETS AND SHALL COMPLY WITH ART. 210.52 (C) (6) EXCEPTION TO (6) CEC 2022.
15. LIGHTING INTEGRAL TO EXHAUST FANS SHALL BE CONTROLLED SEPARATELY FROM THE EXHAUST FANS. 150.0 (K) 28.
16. LIGHTING SHALL HAVE VACUANCY SENSOR. EXHAUST FAN SHALL BE 50 CFM MIN.
17. PROVIDE WATER CLOSETS TO BE MAX. 1.28 GAL. PER FLUSH.
18. SHOWER/TUB W/ FULL HEIGHT TILE WALLS & TEMPERED GLASS ENCLOSURE. USE BUTIUTHE 4,000 WATERPROOFING MEMBRANE OVER 1/2" WONDER BOARD & WALLS, CEILING, & FLOOR.
19. NEW SOLID SURFACE (NON-SLIP RESISTANT) SHOWER PAN AND WALLS.
20. PROVIDE SHOWER FINISHED TO 72" ABOVE DRAIN. PROVIDE PRESSURE OR THERMOSTATIC MIXING VALVE @ SHOWER AND JACUZZI/TUB, WHICH LIMITS WATER TEMPERATURE TO 120°F. SHOWER HEAD SHALL NOT EXCEED 1.8 GALLONS PER MINUTE AT 80 PSI.
21. NEW SINK AND FAUCET. PROVIDE FAUCET TO BE MAX 1.2 CWP AT 80 PSI. METERING FAUCETS SHALL NOT EXCEED 0.2 GALLONS PER METERING CYCLE.
22. WINDOW MODIFICATIONS: REPLACEMENT AND NEW WINDOWS: SHALL HAVE A U-FACTOR EQUAL TO 0.30.
23. PROVIDE NEW COMBO UNIT SMOKE DETECTOR AND CARBON MONOXIDE DETECTOR W/BATTERY BACK-UP IN HALLWAY.
24. PROVIDE NEW 24" X 48" FLAT PROFILE SKYLIGHT.
25. PROVIDE NEW TANKLESS WATER HEATER.
26. NEW WALL 36"x24" ATTIC ACCESS.
27. NEW PREFABRICATED CHAIR (NOT USE).
28. NEW P-1 POSTS ON CONC. BASE 2" ABOVE FINISHED GRADE (TYP.)
29. NEW DECKING OVER FRAMING. S.S.D. FOR FRAMING DETAILS.
30. NEW AIR CONDITIONER.

KITCHEN GENERAL NOTES (2022 CBC REQUIREMENTS):

- WATER CONSERVING PLUMBING FIXTURES REQUIREMENTS:
• KITCHEN FAUCETS SHALL HAVE A MAXIMUM FLOW RATE OF 1.8 GALLONS PER MINUTE, FLOW MAY TEMPORARILY INCREASE TO 2.2 GALLONS PER MINUTE, BUT MUST DEFAULT TO A MAXIMUM OF 1.8 GALLONS PER MINUTE. (CGESC 4.303.1.4.4)
• PRIOR TO FINAL INSPECTION ALL NON-COMPLIANT PLUMBING FIXTURES SHALL BE UPGRADED WITH WATER-CONSERVING FIXTURES AS REQUIRED BY CIVIL CODE 1101.1. A COMPLETED AND SIGNED CERTIFICATE OF COMPLIANCE SHALL BE PROVIDED TO THE BUILDING INSPECTOR.
ELECTRICAL REQUIREMENTS:
• RECEPTACLE OUTLETS SHALL BE INSTALLED SO THAT NO POINT ALONG THE WALL COUNTERTOP OR WORK SURFACE IS MORE THAN 24 INCHES FROM A RECEPTACLE IN THAT SPACE. [CEC 210.52(C)(1)]
• RECEPTACLE OUTLETS SHALL BE INSTALLED AT EACH KITCHEN COUNTERTOP AND WORK SURFACE THAT IS 12 INCHES OR UNDER. [CEC 210.52(C)(1)]
• AT LEAST ONE RECEPTACLE OUTLET SHALL BE INSTALLED AT EACH ISLAND OR PENINSULAR COUNTER SPACE WITH A LONG DIMENSION OF 24 INCHES OR GREATER AND A SHORT DIMENSION OF 12 INCHES OR GREATER. [CEC 210-52(C)(2) AND 210.52(C)(3)]
• ALL ELECTRICAL OUTLETS SERVING KITCHEN COUNTERTOPS AND DISHWASHERS SHALL BE GFCI PROTECTED. GROUND FAULT CIRCUIT INTERRUPTERS SHALL BE LOCATED IN A READILY ACCESSIBLE LOCATION. [CEC 210.8(A)(D)]
• AT LEAST TWO SEPARATE 20-AMPERE BRANCH CIRCUITS SHALL BE PROVIDED FOR SMALL KITCHEN APPLIANCES. THESE CIRCUITS ARE LIMITED TO SUPPLYING WALL AND COUNTER SPACE OUTLETS ONLY AND CANNOT SERVE DISHWASHER, MICROWAVE, RANGE HOOD, GARBAGE DISPOSAL, ETC. [CEC 210.11(C)(1) AND 210.52(B)(3)]
• ALL ADDED/REPLACED RECEPTACLES SHALL BE LISTED TAMPER-RESISTANT RECEPTACLES AND SHALL BE ARC FAULT PROTECTED. [CEC 406.12]


2022 BATHROOM REMODEL REQUIREMENTS:

1. PROVIDE WATERPROOFED MATERIAL AT SHOWER WALLS.
2. ALL RECEPTACLES SHALL BE GFCI PROTECTED AND CONNECTED TO A DEDICATED 15 AND 20 AMPS CIRCUIT. [CEC 210.8.A]
3. ALL ILLUMINATED LIGHTING SHALL BE HIGH EFFICIENCY. (A/C ENERGY EFF. STANDARDS, SECTION 1500(K))
4. EXHAUST FANS ARE REQUIRED IN ALL BATHROOMS, EVEN IF AN OPERABLE WINDOW IS INSTALLED. CPC 303.57.
5. EXHAUST FANS AND LIGHTING SHALL HAVE SEPARATE CONTROL SWITCHES, (EVEN IF A COMBINATION UNIT IS INSTALLED), THE EXHAUST FAN MAY NEED TO BE SUPPLIED BY A GFCI PROTECTED CIRCUIT BASED ON THE MANUFACTURER'S REQUIREMENTS. CEC 150.0 (K)(28)
6. EXHAUST FANS SHALL TERMINATE A MINIMUM OF 3 FT FROM PROPERTY LINE AND 3 FT FROM OPENINGS INTO A BUILDING. (CMC 502.2.1)
7. EXHAUST FANS AT SHOWER SHALL BE LISTED FOR WET LOCATION AND SHALL BE GFCI PROTECTED. CEC 210.8
8. SHOWER ENCLOSURE DOORS SHALL OPEN OUTWARD AND MAINTAIN 22" MIN CLEARANCE. CPC 408.5
9. SHOWER COMPARTMENT SHALL BE A MINIMUM 1,024 SQUARE INCHES ENCOMPASSING A 30"X18" CIRCLE. CPC 408.6
10. WATER CLOSETS (MAXIMUM 1.28 GPM/LA SHALL BE CLEAR 30 INCHES WIDE 15 INCHES ON CENTER) AND 24 INCHES IN FRONT. CPC 402.5
11. SHOWER HEADS (MAXIMUM 1.8 GPM CPC 408.2 & FAUCETS (MAXIMUM 1.2 GPM CPC 407.2)
12. BATH/TUB/WHIRLPOOLS AND SHOWER VALVES SHALL BE APPROVED PRESSURE-BALANCED OR THERMOSTATIC MIXING TYPE ADJUSTED TO A MAXIMUM OF 120 DEGREES. CPC 408.3

legend

- (E) STUD WALL TO REMAIN
(E) WALL, DOORS AND WINDOWS TO REMOVE
(N) 2x STUD WALL - EXTERIOR WALL TO RECEIVE 2X6 WITH R-13 BATT. INSULATION SEE: TITLE 24 FOR MORE INFO. EXTERIOR ELEVATION REFERENCE TAG
DETAIL NUMBER SHEET NUMBER

- DEMOLISHED WALL AREA: 172.6 sq
- NEW WALL AREA: 667.9 sq

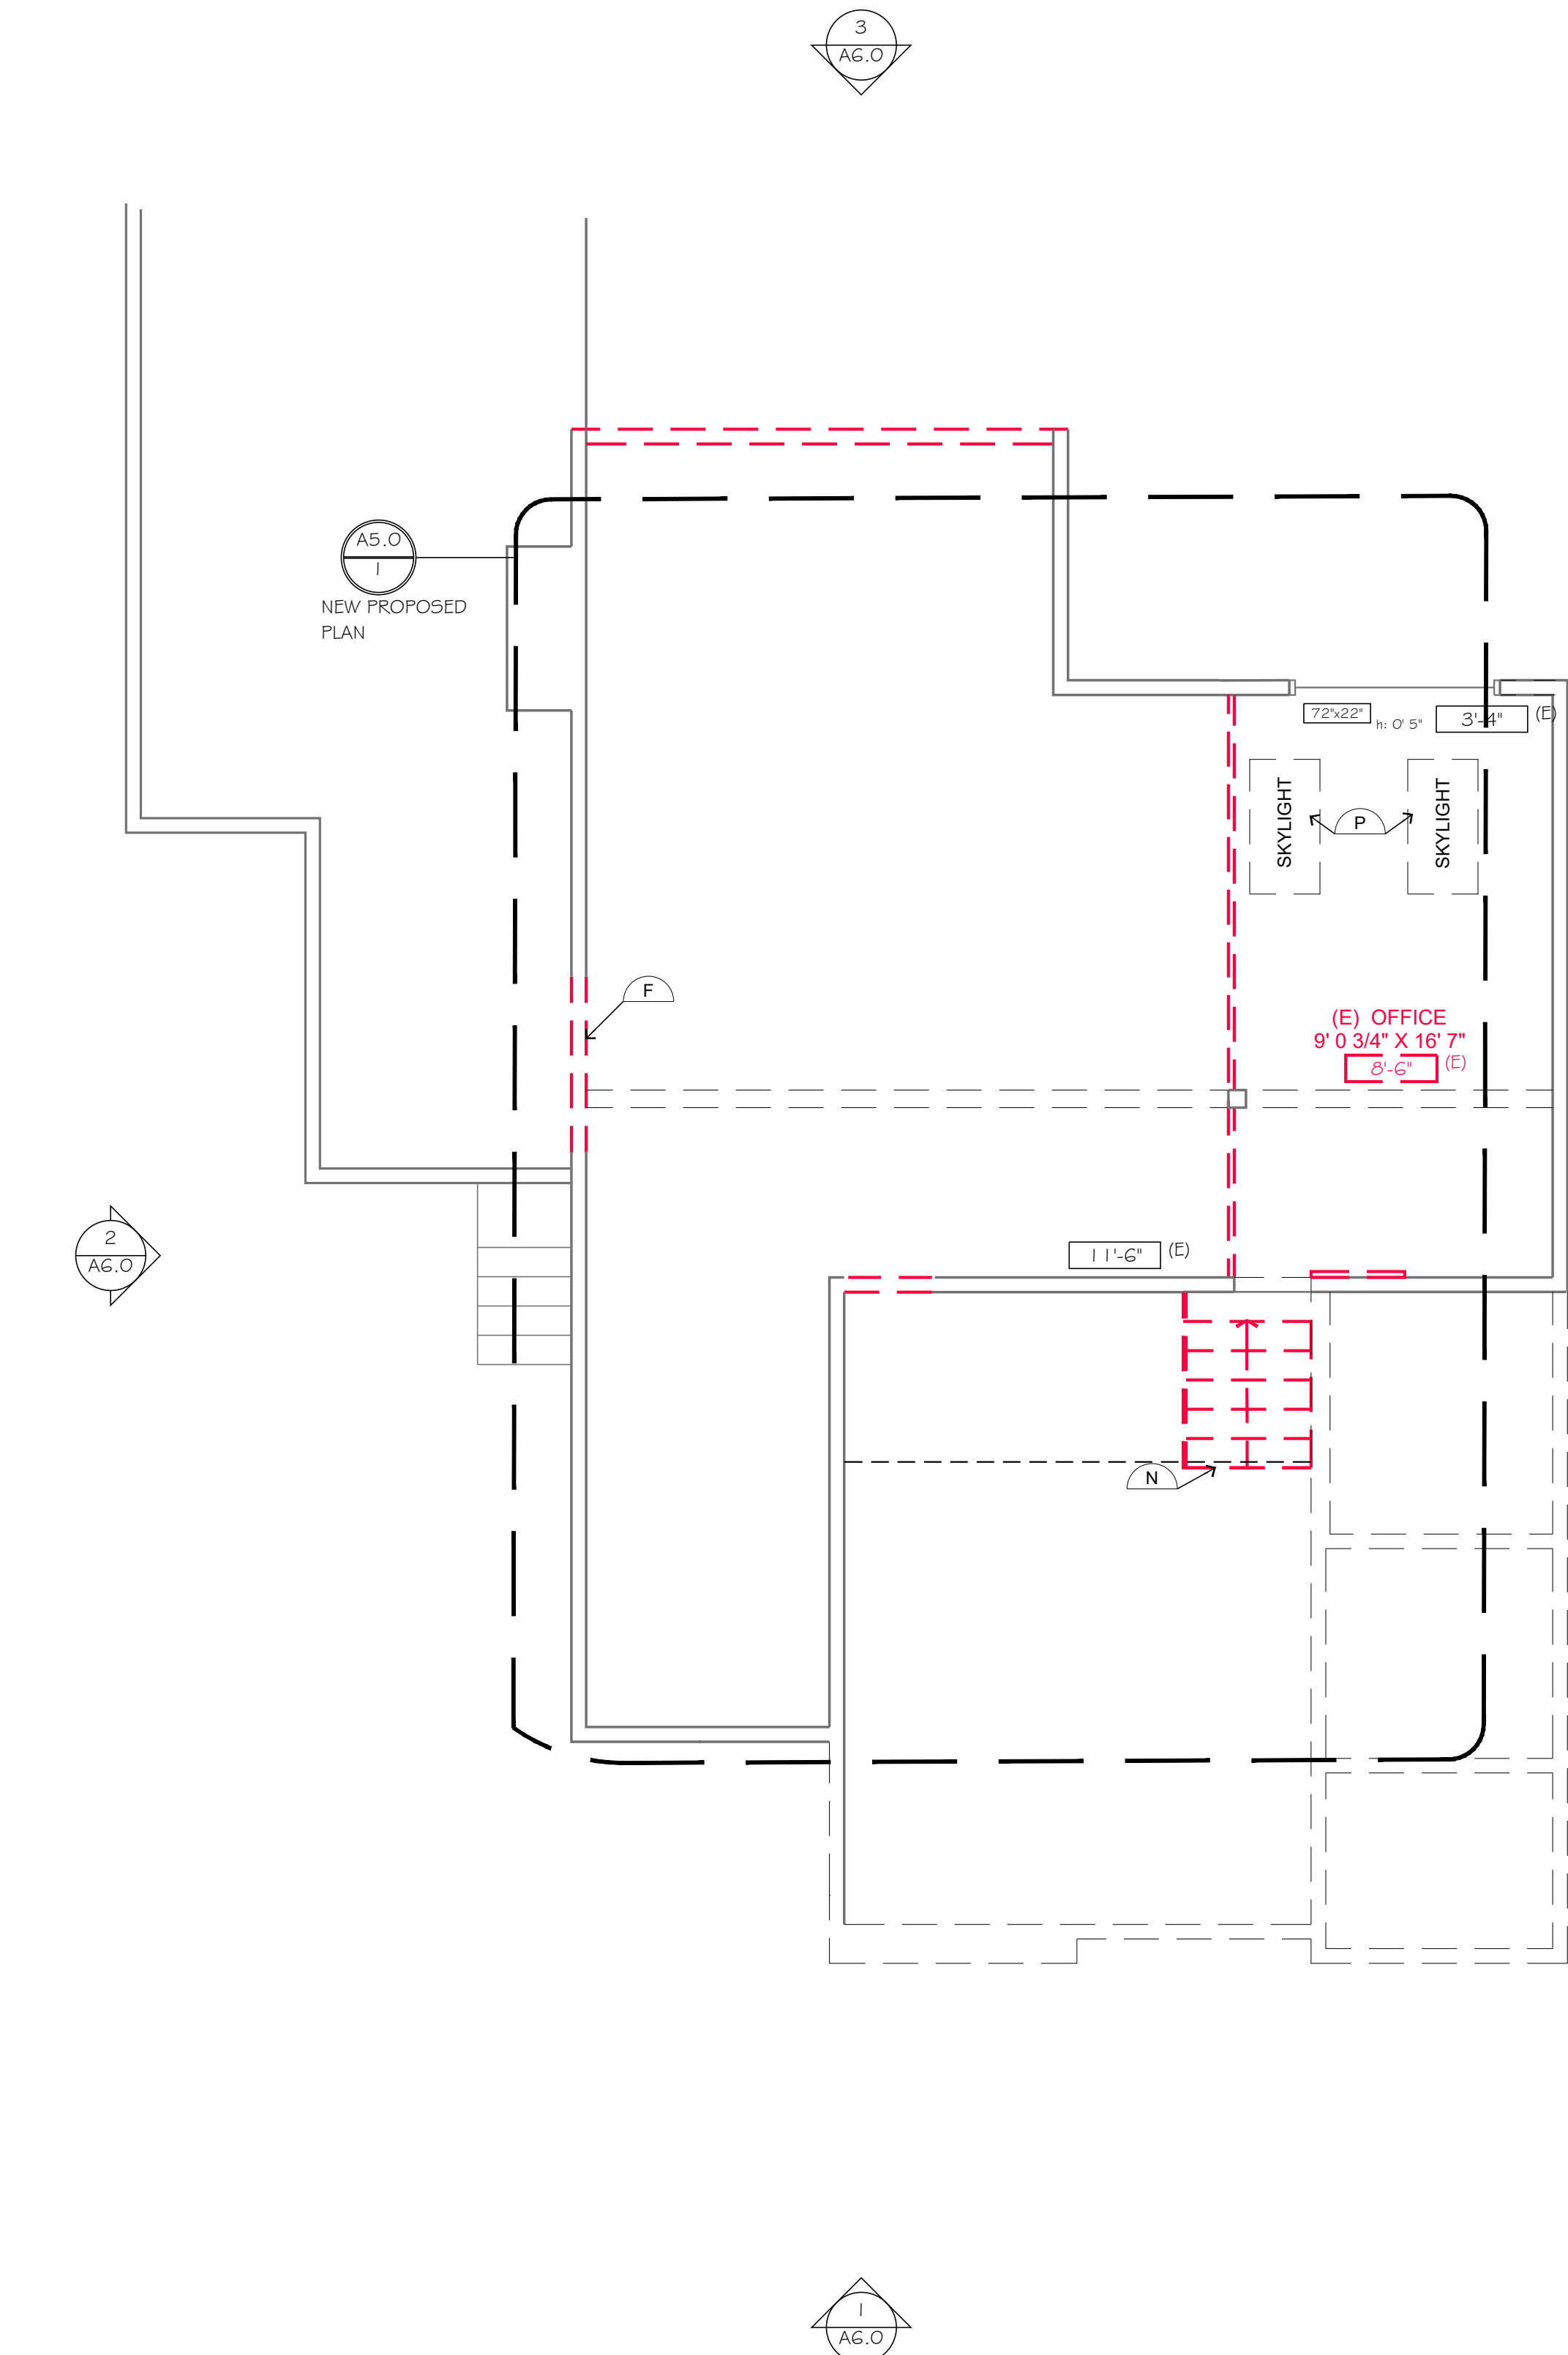

EXISTING AND DEMO THIRD FLOOR PLAN

SCALE: 1/4" = 1'-0"

1

SMOKE ALARMS: DWELLINGS ARE TO BE EQUIPPED WITH SMOKE ALARMS INSTALLED IN THE FOLLOWING LOCATIONS: (CRC 314.4)

- IN EACH EXISTING SLEEPING ROOM.
 - OUTSIDE EACH SEPARATE SLEEPING AREA IN THE IMMEDIATE VICINITY OF THE BEDROOMS.
 - ON EACH STORY INCLUDING BASEMENTS AND HABITABLE ATTICS, NOT INCLUDING CRAWL SPACES AND UNINHABITABLE ATTICS.
 - INSTALLED NOT LESS THAN 3 FEET HORIZONTALLY FROM THE DOOR OR OPENING OF A BATHROOM THAT CONTAINS A BATHTUB OR SHOWER UNLESS THIS WOULD PREVENT PLACEMENT OF A SMOKE ALARM REQUIRED BY CRC R314.3(4).
 - CARBON MONOXIDE ALARMS: DWELLINGS THAT HAVE ATTACHED GARAGES WITH AN OPENING THAT COMMUNICATES WITH THE DWELLING UNIT, OR FUEL BURNING APPLIANCES, OR FIRE PLACE ARE TO BE EQUIPPED WITH CARBON MONOXIDE ALARMS INSTALLED IN THE FOLLOWING LOCATIONS: (CRC 315.3)
 - OUTSIDE EACH SEPARATE SLEEPING AREA IN THE IMMEDIATE VICINITY OF THE BEDROOMS.
 - ON EVERY OCCUPABLE LEVEL OF A DWELLING UNIT INCLUDING BASEMENTS.
 - WHERE A FUEL-BURNING APPLIANCE IS LOCATED WITHIN A BEDROOM OR ITS ATTACHED BATHROOM, A CARBON MONOXIDE ALARM SHALL BE INSTALLED WITHIN THE BEDROOM.
- ALARM INTERCONNECTION AND POWER: SMOKE AND CARBON MONOXIDE ALARMS ARE REQUIRED TO BE INTERCONNECTED SUCH THAT ACTIVATION OF ONE ALARM WILL ACTIVATE ALL OF THE ALARMS AND SHALL RECEIVE THEIR PRIMARY POWER FROM THE BUILDING WIRING. EXCEPTION: WHERE REPAIRS OR ALTERATIONS TO EXISTING BUILDINGS DO NOT RESULT IN THE REMOVAL OF WALL AND CEILING FINISHES AND THERE IS NO ACCESS BY MEANS OF ATTIC, BASEMENT OR CRAWL SPACE. [CRC 314.4 AND §314.6]

VENTILATION REQUIREMENTS:


- TERMINATION OF ALL ENVIRONMENTAL AIR DUCTS SHALL BE AT LEAST 3 FEET FROM PROPERTY LINE AND FROM OPENINGS INTO THE BUILDING, AND 10 FEET FROM A FORCED AIR INLET. [CMC 502.2.1]
- WHOLE-BUILDING VENTILATION: KITCHENS REQUIRE VENTILATION AIR FLOW AT 100 CUBIC FEET PER MINUTE OR MORE FOR INTERMEDIATE SYSTEMS OR 5 AIR CHANGES PER HOUR FOR CONTINUOUS SYSTEMS. [ASHRAE 62.2]

WINDOW MODIFICATIONS: REPLACEMENT AND NEW WINDOWS:

1. SHALL HAVE A U-FACTOR EQUAL TO 0.30 OR LOWER. EXCEPTIONS: REPLACEMENT SKYLIGHTS, OR NEW SKYLIGHTS UP TO 16 SQUARE FEET, MAY HAVE A U-FACTOR OF 0.35, WHEN 75 SQUARE FEET OR LESS OF PENETRATION IS REPLACED WINDOWS MAY HAVE A U-FACTOR OF 0.40. [CMC 150.2(B) TABLE 150.1-A]
2. FOR WINDOW MODIFICATIONS IN THE HILLSIDE FIRE ZONES 2 AND 3 REFER TO WINDOW AND DOOR CODE COMPLIANCE CHECKLIST

BUILDING ENVELOPE MODIFICATIONS:

EXTERIOR WALL, FLOOR AND ROOF FRAMING SPACES OPENED UP DURING THE COURSE OF REMODEL SHALL BE INSULATED. R-13 (2X4 WALL), R-20 (2X6 WALL), R-19 (FLOOR), AND R-19 (ATTIC/ROOF) INSULATION. [CEC 150.5(A)(C)(D)]

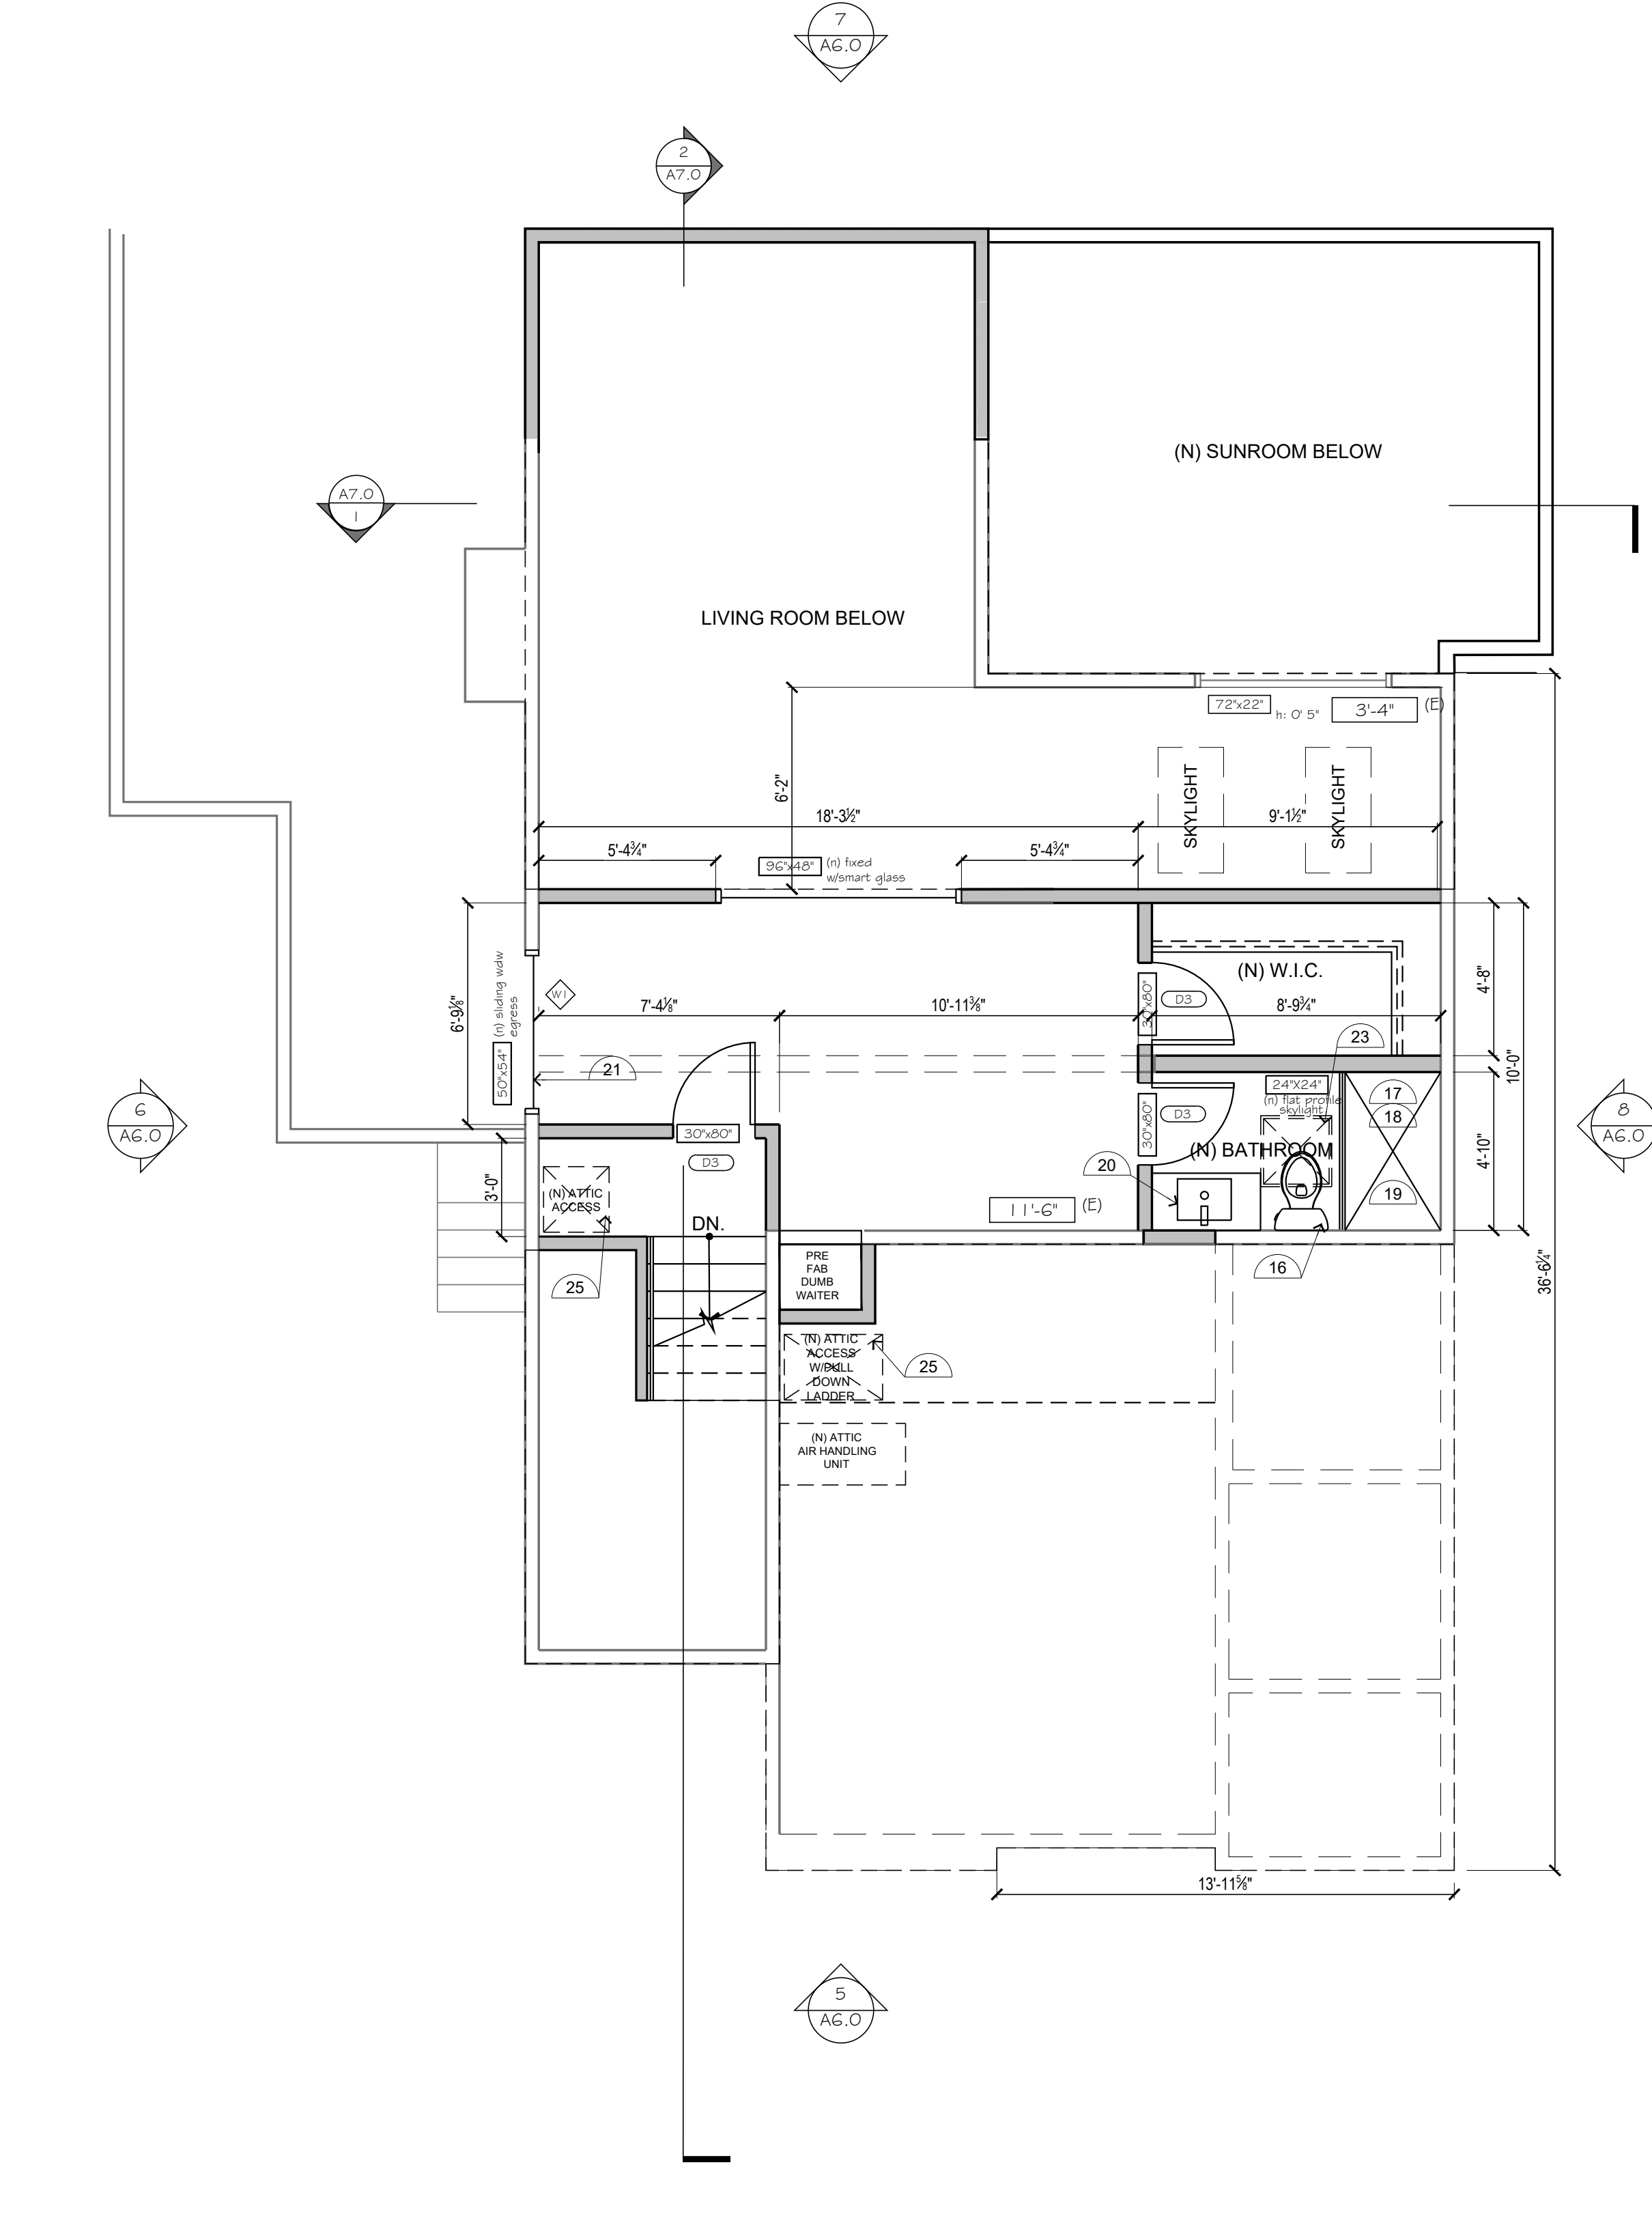

NEW PROPOSED THIRD FLOOR PLAN

SCALE: 1/4" = 1'-0"

2



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Residence

Remodeling & Addition

130 Vasona Oaks Dr,
Los Gatos, CA 95032

description date

1 planning comments response 6.9.2025

2 planning comments resp. 6.19.2025

3

4

5

6

revision history

client review

plan check

bidding

construction

drawing release status

date 4.19.2024

proj num

proj mgr

proj arch




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EXISTING AND DEMO AND NEW PROPOSED THIRD FLOOR PLANS

sheet number






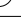

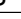





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legend

- | | |
|---|---|
| | (E) STUD WALL TO REMAIN |
|  | (E) WALL, DOORS AND WINDOWS TO REMOVE |
|  | (N) 2x STUD WALL - |
|  | EXTERIOR WALL TO RECEIVE 2X6 WITH R-13 BATT. INSULATION |
| | SEE TITLE 24 FOR MORE INFO. |
| | EXTERIOR ELEVATION REFERENCE TAG |



electrical legend

- | | |
|---|--|
|  | LED WALL HUNG LIGHT FIXTURE BATHROOM |
|  | 4" LED RECESSED LIGHT FIXTURE |
|  | BATHROOM EXHAUST FAN
W/LED LIGHT AND MOISTURE CONTROL |
|  | (E) SMOKE AND CARBON MONOXIDE DETECTOR |
|  | SWITCH @ 48" U.F.F. |
|  | VACANCY SENSOR SWITCH @ 48" A.F.F. |
|  | DUPLEX OUTLET @ 12" A.F.F. / 32"-36" A.F.F. AT COUNTER. |
|  | G.F.I. OUTLET @ 32" - 36" A.F.F. |
|  | GAS STUB |
|  | LED RECESSED LIGHT FIXTURE WITH WATER PROOF LENS |
|  | LED PENDANT LIGHT FIXTURE KITCHEN |
|  | 240V G.F.I. OUTLET @ 32" - 36" A.F.F. |
|  | EXTERIOR LED LIGHT FIXTURE WITH OCCUPANT SENSOR |

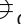electrical plan sheet notes

1. COGENERATION TYPE AIR-RAIL CROUCH INTERFERENCE SHALL PROTECT ALL RECEPTACLES IN ALL BEDROOMS, DINING ROOMS, LIVING ROOMS, PARLOUS, LIBRARIES, DEN'S DINING ROOMS, RECREATION ROOMS, CLOSETS, KITCHENS, LAUNDRY AREAS, HALLWAYS OR SIMILAR ROOMS OR AREAS WITH BRANCH CIRCUITS THAT CARRY 120 VOLTS, SINGLE-PHASE, 1- AND 2-WIRE RECEPTACLE OUTLETS, AND BE EASILY ACCESSIBLE. SEE CC SECTION 210.2 AND 210.2 (C)
2. TWO 20-AMP GFCI PROTECTED CIRCUITS WILL BE PROVIDED IN THE KITCHEN COUNTER AND ISLAND OUTLETS AND SHALL COMPLY WITH ART. 210.52 (C) (5) EXCEPTION TO (C) 5.02 2022
3. LIGHTING INTENSITY TO EXHAUST FANS SHALL BE CONTROLLED SEPARATELY FROM THE EXHAUST FANS. 150.0 (C) 28
4. LIGHTING SHALL HAVE VACUANCY SENSOR. EXHAUST FAN SHALL BE 50 CFM MIN.
5. PROVIDE NEW COMBO ULT SMOKE DETECTOR AND CARBON MONOXIDE DETECTOR W/BATTERY BACK-UP IN HALLWAY.

LIGHTING REQUIREMENTS

- ALL INSTALLED LUMINAIRES SHALL BE HIGH EFFICACY. [CNC 150.0 TABLE 150.0-A]
- UNDER CABINET LIGHTING SHALL BE CONTROLLED SEPARATELY FROM CEILING LIGHTING
- CEILING LIGHTING SHALL BE CONTROLLED SEPARATELY FROM THE OTHER. [CNC 150.0(2)(K)]
- LUMINAIRES RECESSED INTO INSULATED CEILINGS:
- (A) SHALL BE LISTED FOR ZERO CLEARANCE INSULATION COVER (IC RATED)
 - (B) SHALL INCLUDE A LABEL CERTIFYING AIR TIGHT (AT) WITH AIR LEAKAGE LESS THAN 2.0 CFM AT 75 PASCAIS;
 - (C) SHALL BE SEALED WITH A GASKET OR CAULK BETWEEN THE LUMINARY HOUSING AND CEILING;
 - (D) RECESSED LIGHTS ARE EQUIPPED WITH BALLASTS, SHALL ALLOW BALLAST MAINTENANCE AND REPLACEMENT WITHOUT REQUIRING CUTTING OF HOLES IN THE CEILING; AND
 - (E) SHALL NOT CONTAIN SCREW BASE SOCKETS. [CECS SEC.150.0(K)(2)]

SMOKE ALARMS

- DWELLINGS ARE TO BE EQUIPPED WITH SMOKE ALARMS INSTALLED IN THE FOLLOWING LOCATIONS: [CFC 314.14]
- IN EACH EXISTING SLEEPING ROOM.
 - OUTSIDE EACH SEPARATE SLEEPING AREA IN THE IMMEDIATE VICINITY OF THE BEDROOMS.
 - ON EACH STORY INCLUDING BASEMENTS AND HABITABLE ATTICS, NOT INCLUDING CRAWL SPACES AND UNINHABITABLE ATTICS.
- INSTALLED NOT LESS THAN 3 FEET HORIZONTALLY FROM THE DOOR OR OPENING OF A BATHROOM THAT CONTAINS A BATHTUB OR SHOWER UNLESS THIS WOULD PREVENT PLACEMENT OF A SMOKE ALARM REQUIRED BY CFC R314.3(4).

CARBON MONOXIDE ALARMS



- DWELLINGS THAT HAVE ATTACHED GARAGES WITH AN OPENING THAT COMMUNICATES WITH THE DWELLING UNIT, OR FUEL BURNING APPLIANCES, OR FIRE PLACE ARE TO BE EQUIPPED WITH CARBON MONOXIDE ALARMS INSTALLED IN THE FOLLOWING LOCATIONS: [CPC 315.3]
 - OUTSIDE EACH SEPARATE SLEEPING AREA IN THE IMMEDIATE VICINITY OF THE BEDROOMS.
 - ON EVERY OCCUPIABLE LEVEL OF A DWELLING UNIT INCLUDING BASEMENTS.
 - WHERE A FUEL-BURNING APPLIANCE IS LOCATED WITHIN A BEDROOM OR ITS ATTACHED BATHROOM. A CARBON MONOXIDE ALARM SHALL BE INSTALLED WITHIN THE BEDROOM.
- ALARM INTERCONNECTION AND POWER:**

ALARM INTERCONNECTION AND POWER

- SMOKE AND CARBON MONOXIDE ALARMS ARE REQUIRED TO BE INTERCONNECTED SUCH THAT ACTIVATION OF ONE ALARM WILL ACTIVATE ALL OF THE ALARMS AND SHALL RECEIVE THEIR PRIMARY POWER FROM THE BUILDING WIRING, EXCEPTION: WHERE REPAIRS OR ALTERATIONS TO EXISTING BUILDINGS DO NOT RESULT IN THE REMOVAL OF WALL AND CEILING FINISHES AND THERE IS NO ACCESS BY MEANS OF ATTIC, BASEMENT OR CRAWL SPACE. [CRC 314.4 AND §314.6]

SMOKE AND CARBON MONOXIDE DETECTOR

- WHEN ALTERATIONS, REPAIRS OR ADDITIONS REQUIRING A PERMIT OCCUR, THE INDIVIDUAL DWELLING UNIT SHALL BE EQUIPPED WITH SMOKE ALARMS LOCATED AS REQUIRED FOR NEW DWELLINGS. [R314.2.2]

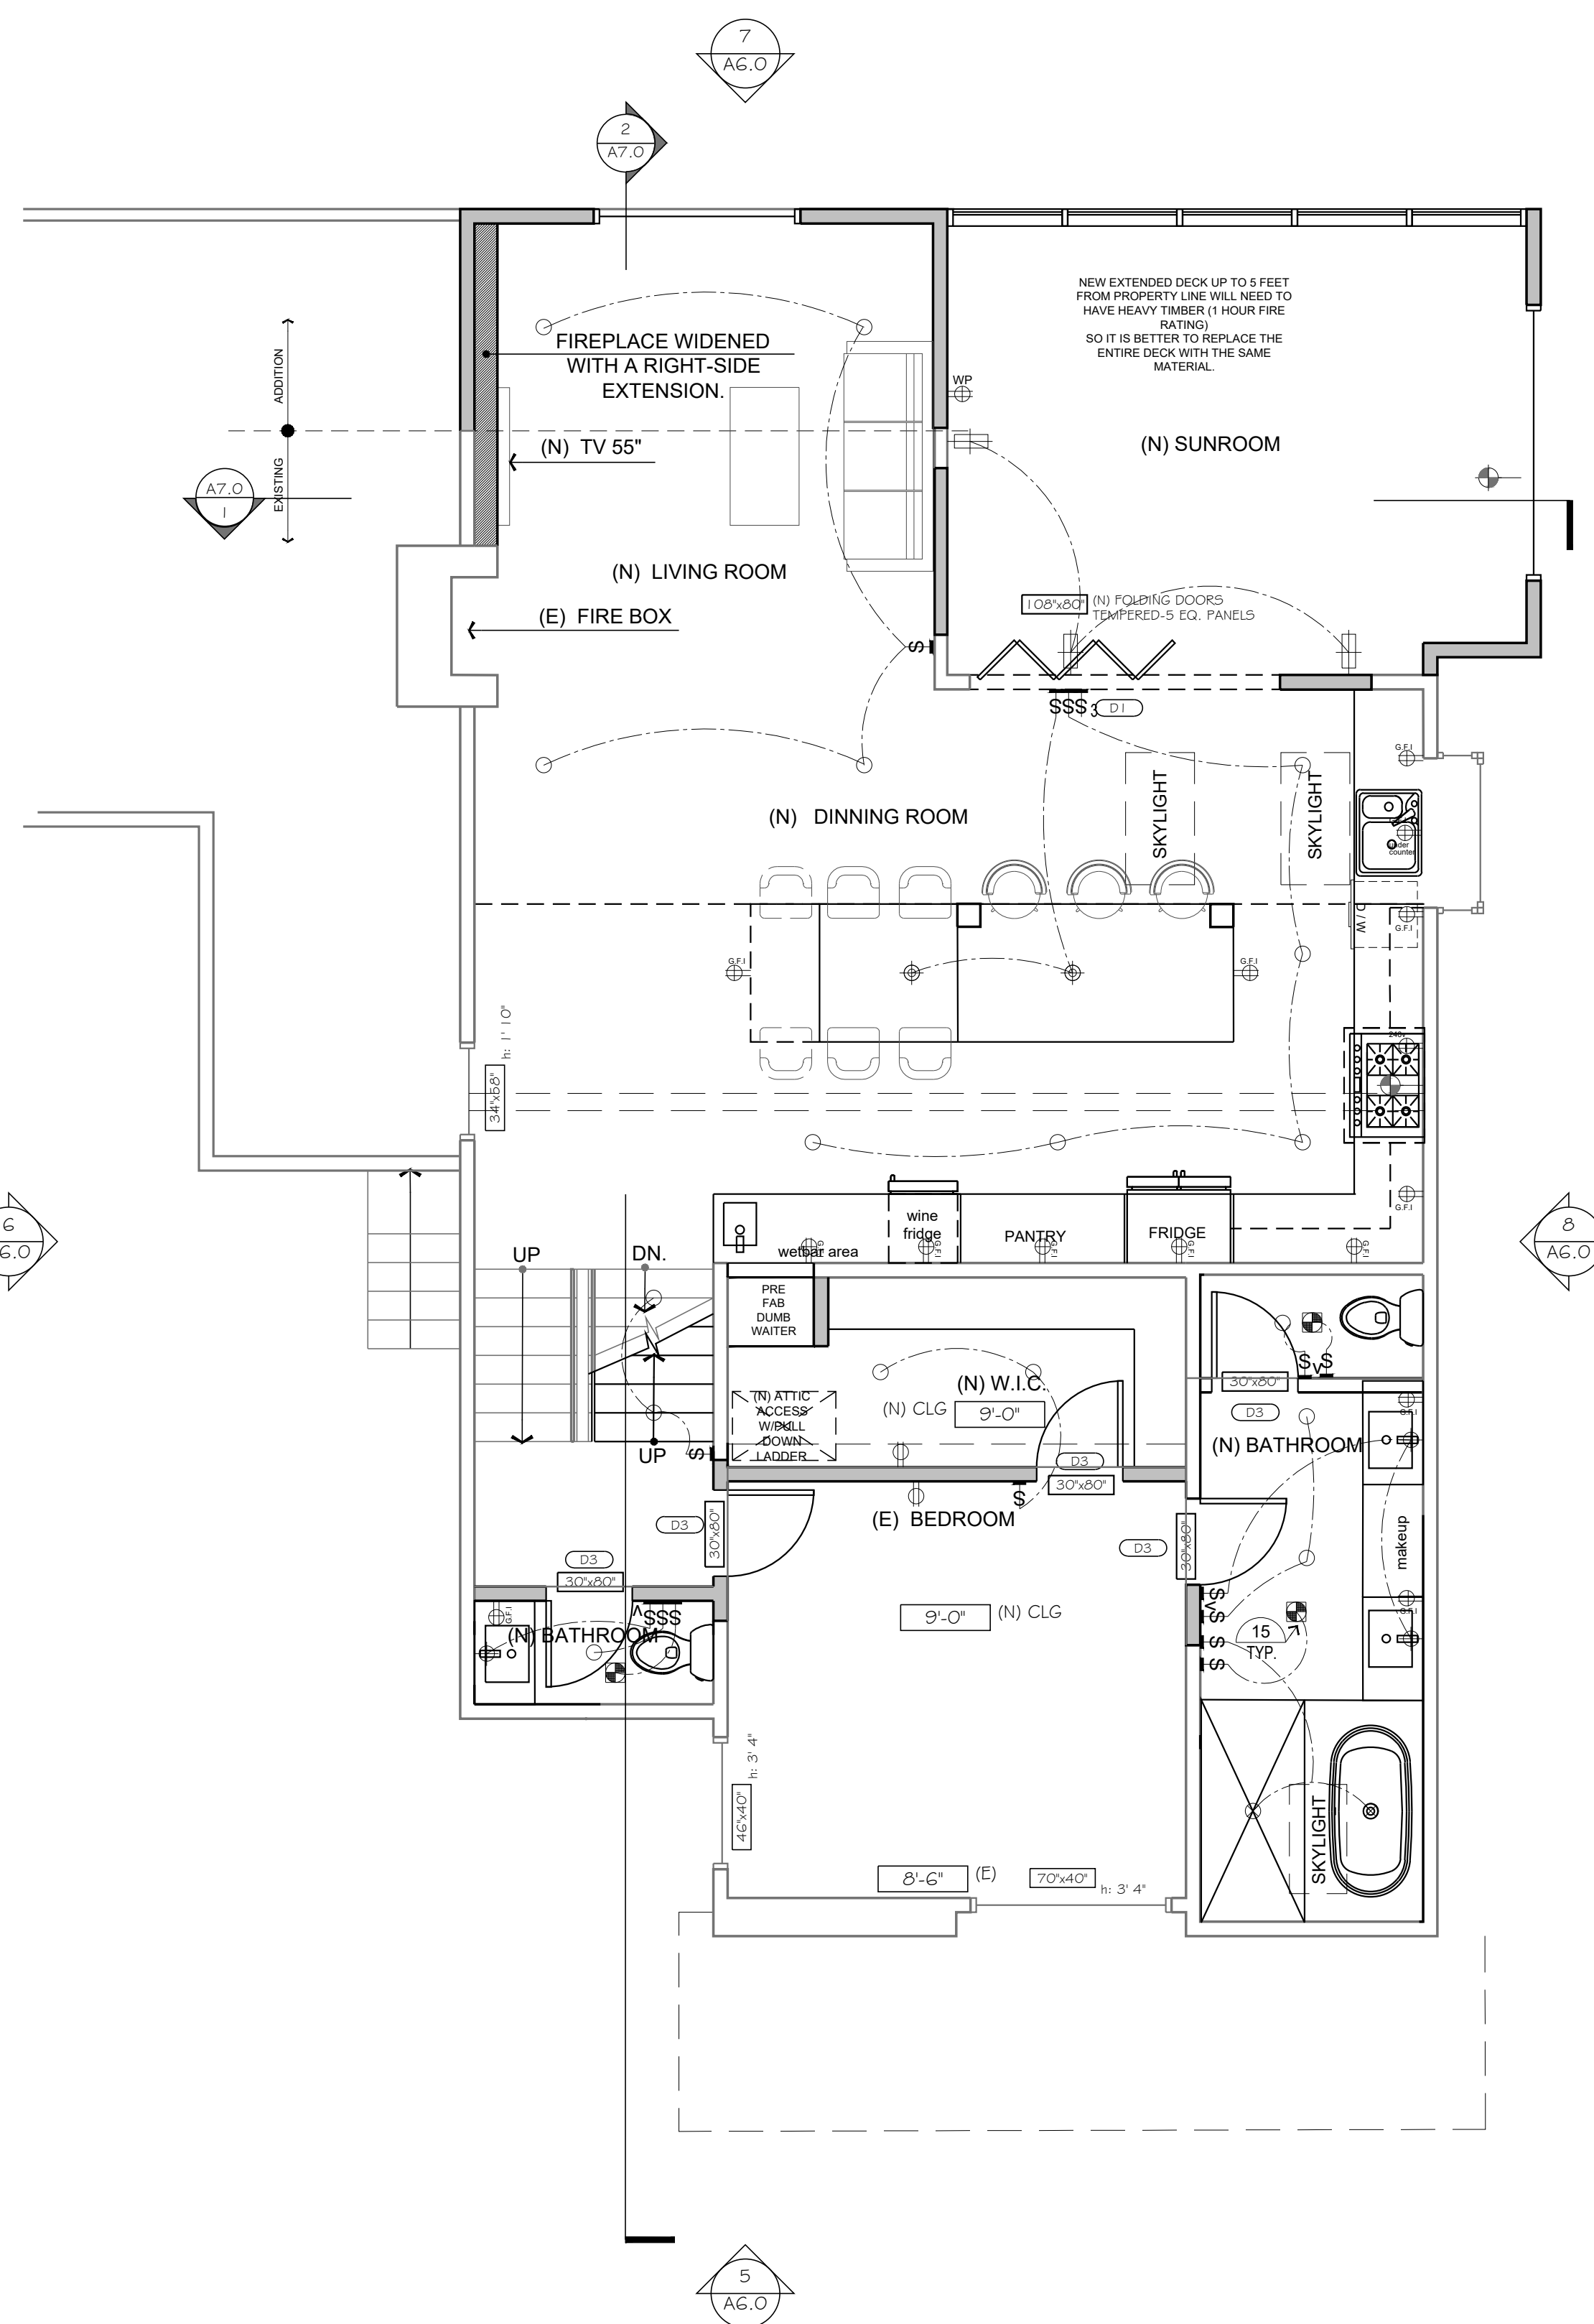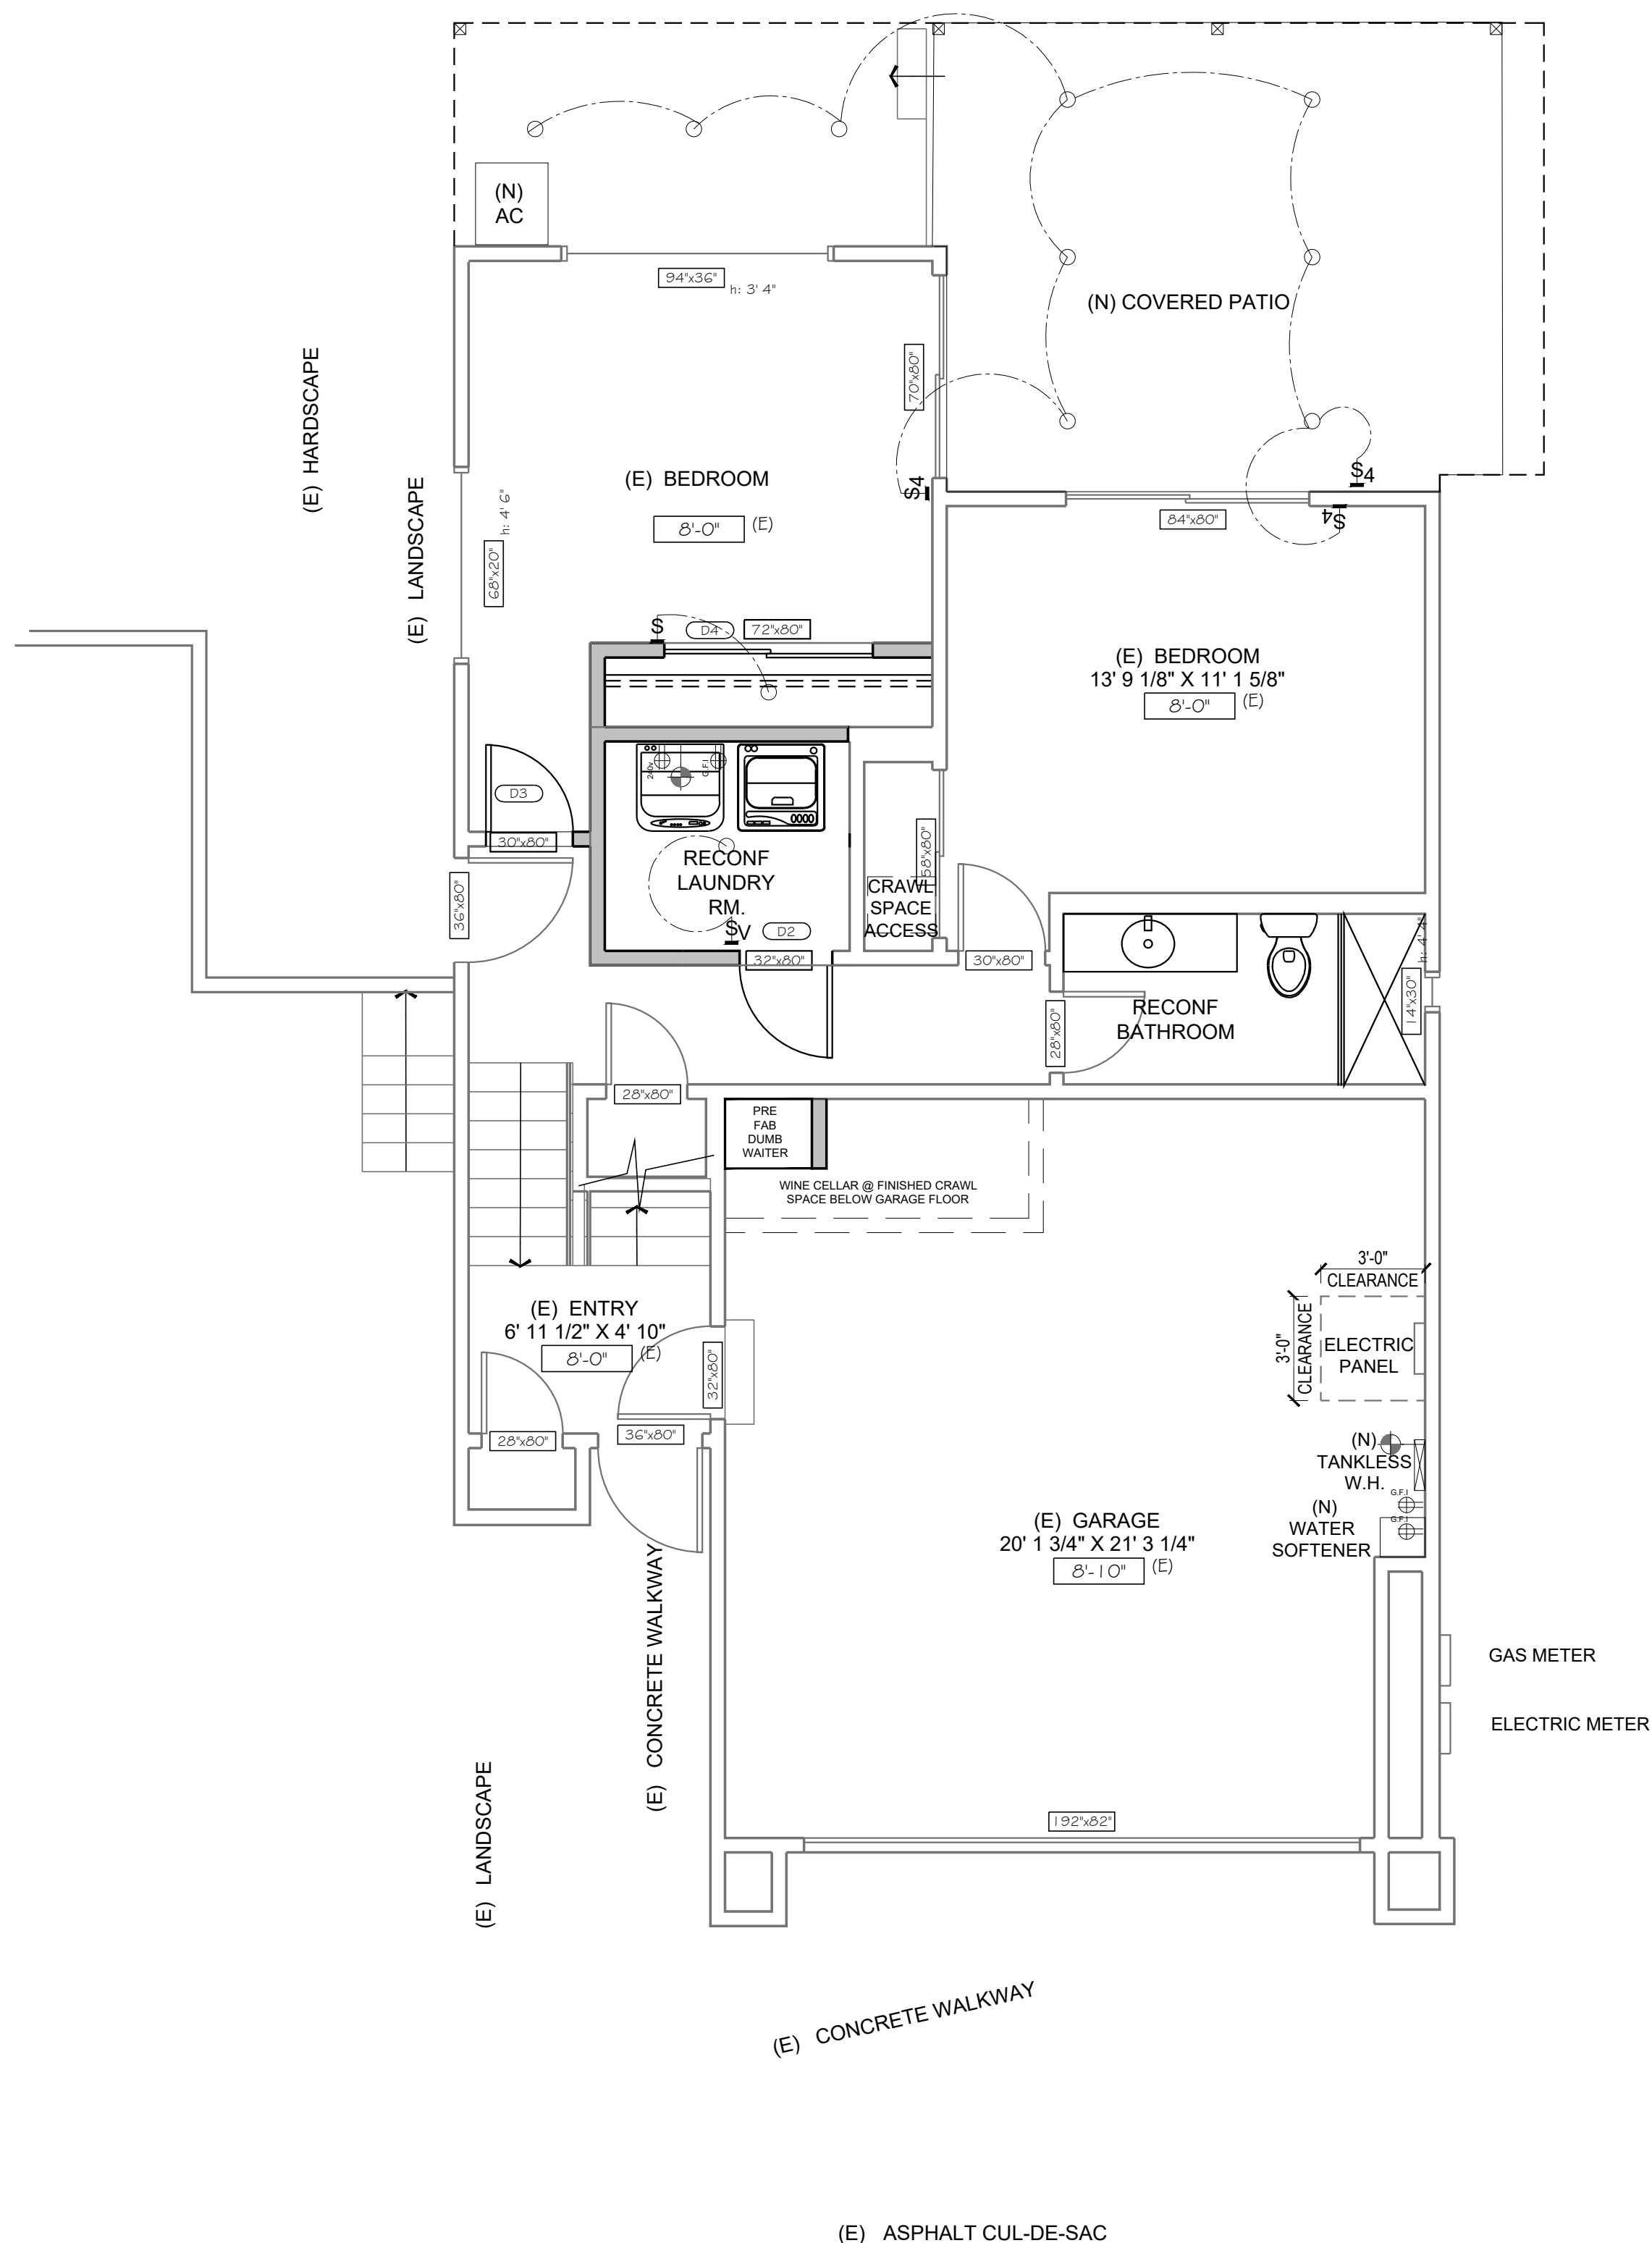

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Residence

Remodeling & Addition

130 Vasona Oaks Dr,
Los Gatos, CA 95032

	#	description	date
revision history	1	planning comments response	6.9.2025
	2	planning comments resp.	6.19.2025
	3		
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	date
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<input type="radio"/> bidding	
<input type="radio"/> construction	

late	4.19.2024
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um
rojproj
mgrproj
arch

scale AS NOTE

PROPOSED

PROPOSED FIRST FLOOR PLANS

sheet
number

A3.0

legend

(E) STUD WALL TO REMAIN

(E) WALL, DOORS AND WINDOWS TO REMOVE

(N) 2x STUD WALL -
EXTERIOR WALL TO RECEIVE 2X6 WITH R-13 BATT. INSULATION
SEE TITLE 24 FOR MORE INFO.
EXTERIOR ELEVATION REFERENCE TAG

DETAIL NUMBER
SHEET NUMBER

electrical legend

LED WALL HUNG LIGHT FIXTURE BATHROOM

4" LED RECESSED LIGHT FIXTURE

BATHROOM EXHAUST FAN
W/ LED LIGHT AND MOISTURE CONTROL

(E) SMOKE AND CARBON MONOXIDE DETECTOR

SWITCH @ 48" U.F.F.

VACANCY SENSOR SWITCH @ 48" A.F.F.

DUPLEX OUTLET @ 12" A.F.F. / 32"-36" A.F.F. AT COUNTER.

G.F.I. OUTLET @ 32" - 36" A.F.F.

GAS STUB

LED RECESSED LIGHT FIXTURE WITH WATER PROOF LENS

LED PENDANT LIGHT FIXTURE KITCHEN

240V G.F.I. OUTLET @ 32" - 36" A.F.F.

EXTERIOR LED LIGHT FIXTURE WITH OCCUPANT SENSOR

electrical plan sheet notes

1. COMBINATION TYPE ARC-FAULT CIRCUIT INTERRUPTER SHALL PROTECT ALL RECEPTACLES IN ALL BEDROOMS, DINING ROOMS, LIVING ROOMS, PARLOYS, LIBRARIES, DEN'S, SUNROOMS, RECREATION ROOMS, CLOSETS, KITCHENS, LAUNDRY AREAS, HALLWAYS OR SIMILAR ROOMS OR AREAS WITH BRANCH CIRCUITS THAT SUPPLY 125 VOLT, SINGLE-PHASE, 15 AND 20-AMP RECEPTACLE OUTLETS, AND BE EASILY ACCESSIBLE. 2022 CEC SECTION 210.12

2. TWO 20-AMP GFI PROTECTED CIRCUITS WILL BE PROVIDED IN THE KITCHEN COUNTER AND ISLAND OUTLETS AND SHALL COMPLY WITH ART. 210.52 (C) (5) EXCEPTION TO (5) CEC 2022

3. LIGHTING INTEGRAL TO EXHAUST FANS SHALL BE CONTROLLED SEPARATELY FROM THE EXHAUST FANS. 150.0 (K) 28. LIGHTING SHALL HAVE VACANCY SENSOR. EXHAUST FAN SHALL BE 50 CFM MIN.

4. PROVIDE NEW COMBO UNIT SMOKE DETECTOR AND CARBON MONOXIDE DETECTOR W/ BATTERY BACK-UP IN HALLWAY.

LIGHTING REQUIREMENTS:

ALL INSTALLED LUMINAIRES SHALL BE HIGH EFFICACY. [CENC 150.0 TABLE 150.0-A]

UNDER CABINET LIGHTING SHALL BE CONTROLLED SEPARATELY FROM CEILING INSTALLED

LIGHTING SUCH THAT ONE CAN BE TURNED ON WITHOUT THE OTHER. [CENC 150.0(2)(K)]

LUMINAIRES RECESSED INTO INSULATED CEILINGS:

(A) SHALL BE LISTED FOR ZERO CLEARANCE INSULATION COVER (IC RATED);

(B) SHALL INCLUDE A LABEL CERTIFYING AIR TIGHT (AT) WITH AIR LEAKAGE LESS THAN 2.0 CFM AT 75 PASCALS;

(C) SHALL BE SEALED WITH A GASKET OR CAULK BETWEEN THE LUMINARY HOUSING AND CEILING;

(D) IF RECESSED LIGHTS ARE EQUIPPED WITH BALLASTS, SHALL ALLOW BALLAST MAINTENANCE AND REPLACEMENT WITHOUT REQUIRING CUTTING OF HOLES IN THE CEILING; AND

(E) SHALL NOT CONTAIN SCREW BASE SOCKETS. [CEES SEC.150(K)12].

SMOKE ALARMS:

DWELLINGS ARE TO BE EQUIPPED WITH SMOKE ALARMS INSTALLED IN THE FOLLOWING LOCATIONS: [CRC 314.4]

IN EACH EXISTING SLEEPING ROOM.

OUTSIDE EACH SEPARATE SLEEPING AREA IN THE IMMEDIATE VICINITY OF THE BEDROOMS.

ON EACH STORY INCLUDING BASEMENTS AND HABITABLE ATTICS, NOT INCLUDING CRAWL SPACES AND UNINHABITABLE ATTICS.

INSTALLED NOT LESS THAN 3 FEET HORIZONTALLY FROM THE DOOR OR OPENING OF A BATHROOM THAT CONTAINS A BATHTUB OR SHOWER UNLESS THIS WOULD PREVENT PLACEMENT OF A SMOKE ALARM REQUIRED BY CRC §314.3(4).

CARBON MONOXIDE ALARMS:

DWELLINGS THAT HAVE ATTACHED GARAGES WITH AN OPENING THAT COMMUNICATES WITH THE DWELLING UNIT, OR FUEL BURNING APPLIANCES, OR FIRE PLACE ARE TO BE EQUIPPED WITH CARBON MONOXIDE ALARMS INSTALLED IN THE FOLLOWING LOCATIONS: [CRC 315.3]

OUTSIDE EACH SEPARATE SLEEPING AREA IN THE IMMEDIATE VICINITY OF THE BEDROOMS.

ON EVERY OCCUPABLE LEVEL OF A DWELLING UNIT INCLUDING BASEMENTS.

WHERE A FUEL-BURNING APPLIANCE IS LOCATED WITHIN A BEDROOM OR ITS ATTACHED BATHROOM, A CARBON MONOXIDE ALARM SHALL BE INSTALLED WITHIN THE BEDROOM.

ALARM INTERCONNECTION AND POWER:


SMOKE AND CARBON MONOXIDE ALARMS ARE REQUIRED TO BE INTERCONNECTED SUCH THAT ACTIVATION OF ONE ALARM WILL ACTIVATE ALL OF THE ALARMS AND SHALL RECEIVE THEIR PRIMARY POWER FROM THE BUILDING WIRING. EXCEPTION: WHERE REPAIRS OR ALTERATIONS TO EXISTING BUILDINGS DO NOT RESULT IN THE REMOVAL OF WALL AND CEILING FINISHES AND THERE IS NO ACCESS BY MEANS OF ATTIC, BASEMENT OR CRAWL SPACE. [CRC 314.4 AND §314.6]

SMOKE AND CARBON MONOXIDE DETECTOR

WHEN ALTERATIONS, REPAIRS OR ADDITIONS REQUIRING A PERMIT OCCUR, THE INDIVIDUAL DWELLING UNIT SHALL BE EQUIPPED WITH SMOKE ALARMS LOCATED AS REQUIRED FOR NEW DWELLINGS. (R314.2.2)


SMOKE AND CARBON MONOXIDE DETECTOR

WHEN ALTERATIONS, REPAIRS OR ADDITIONS REQUIRING A PERMIT OCCUR, THE INDIVIDUAL DWELLING UNIT SHALL BE EQUIPPED WITH SMOKE ALARMS LOCATED AS REQUIRED FOR NEW DWELLINGS. (R314.2.2)

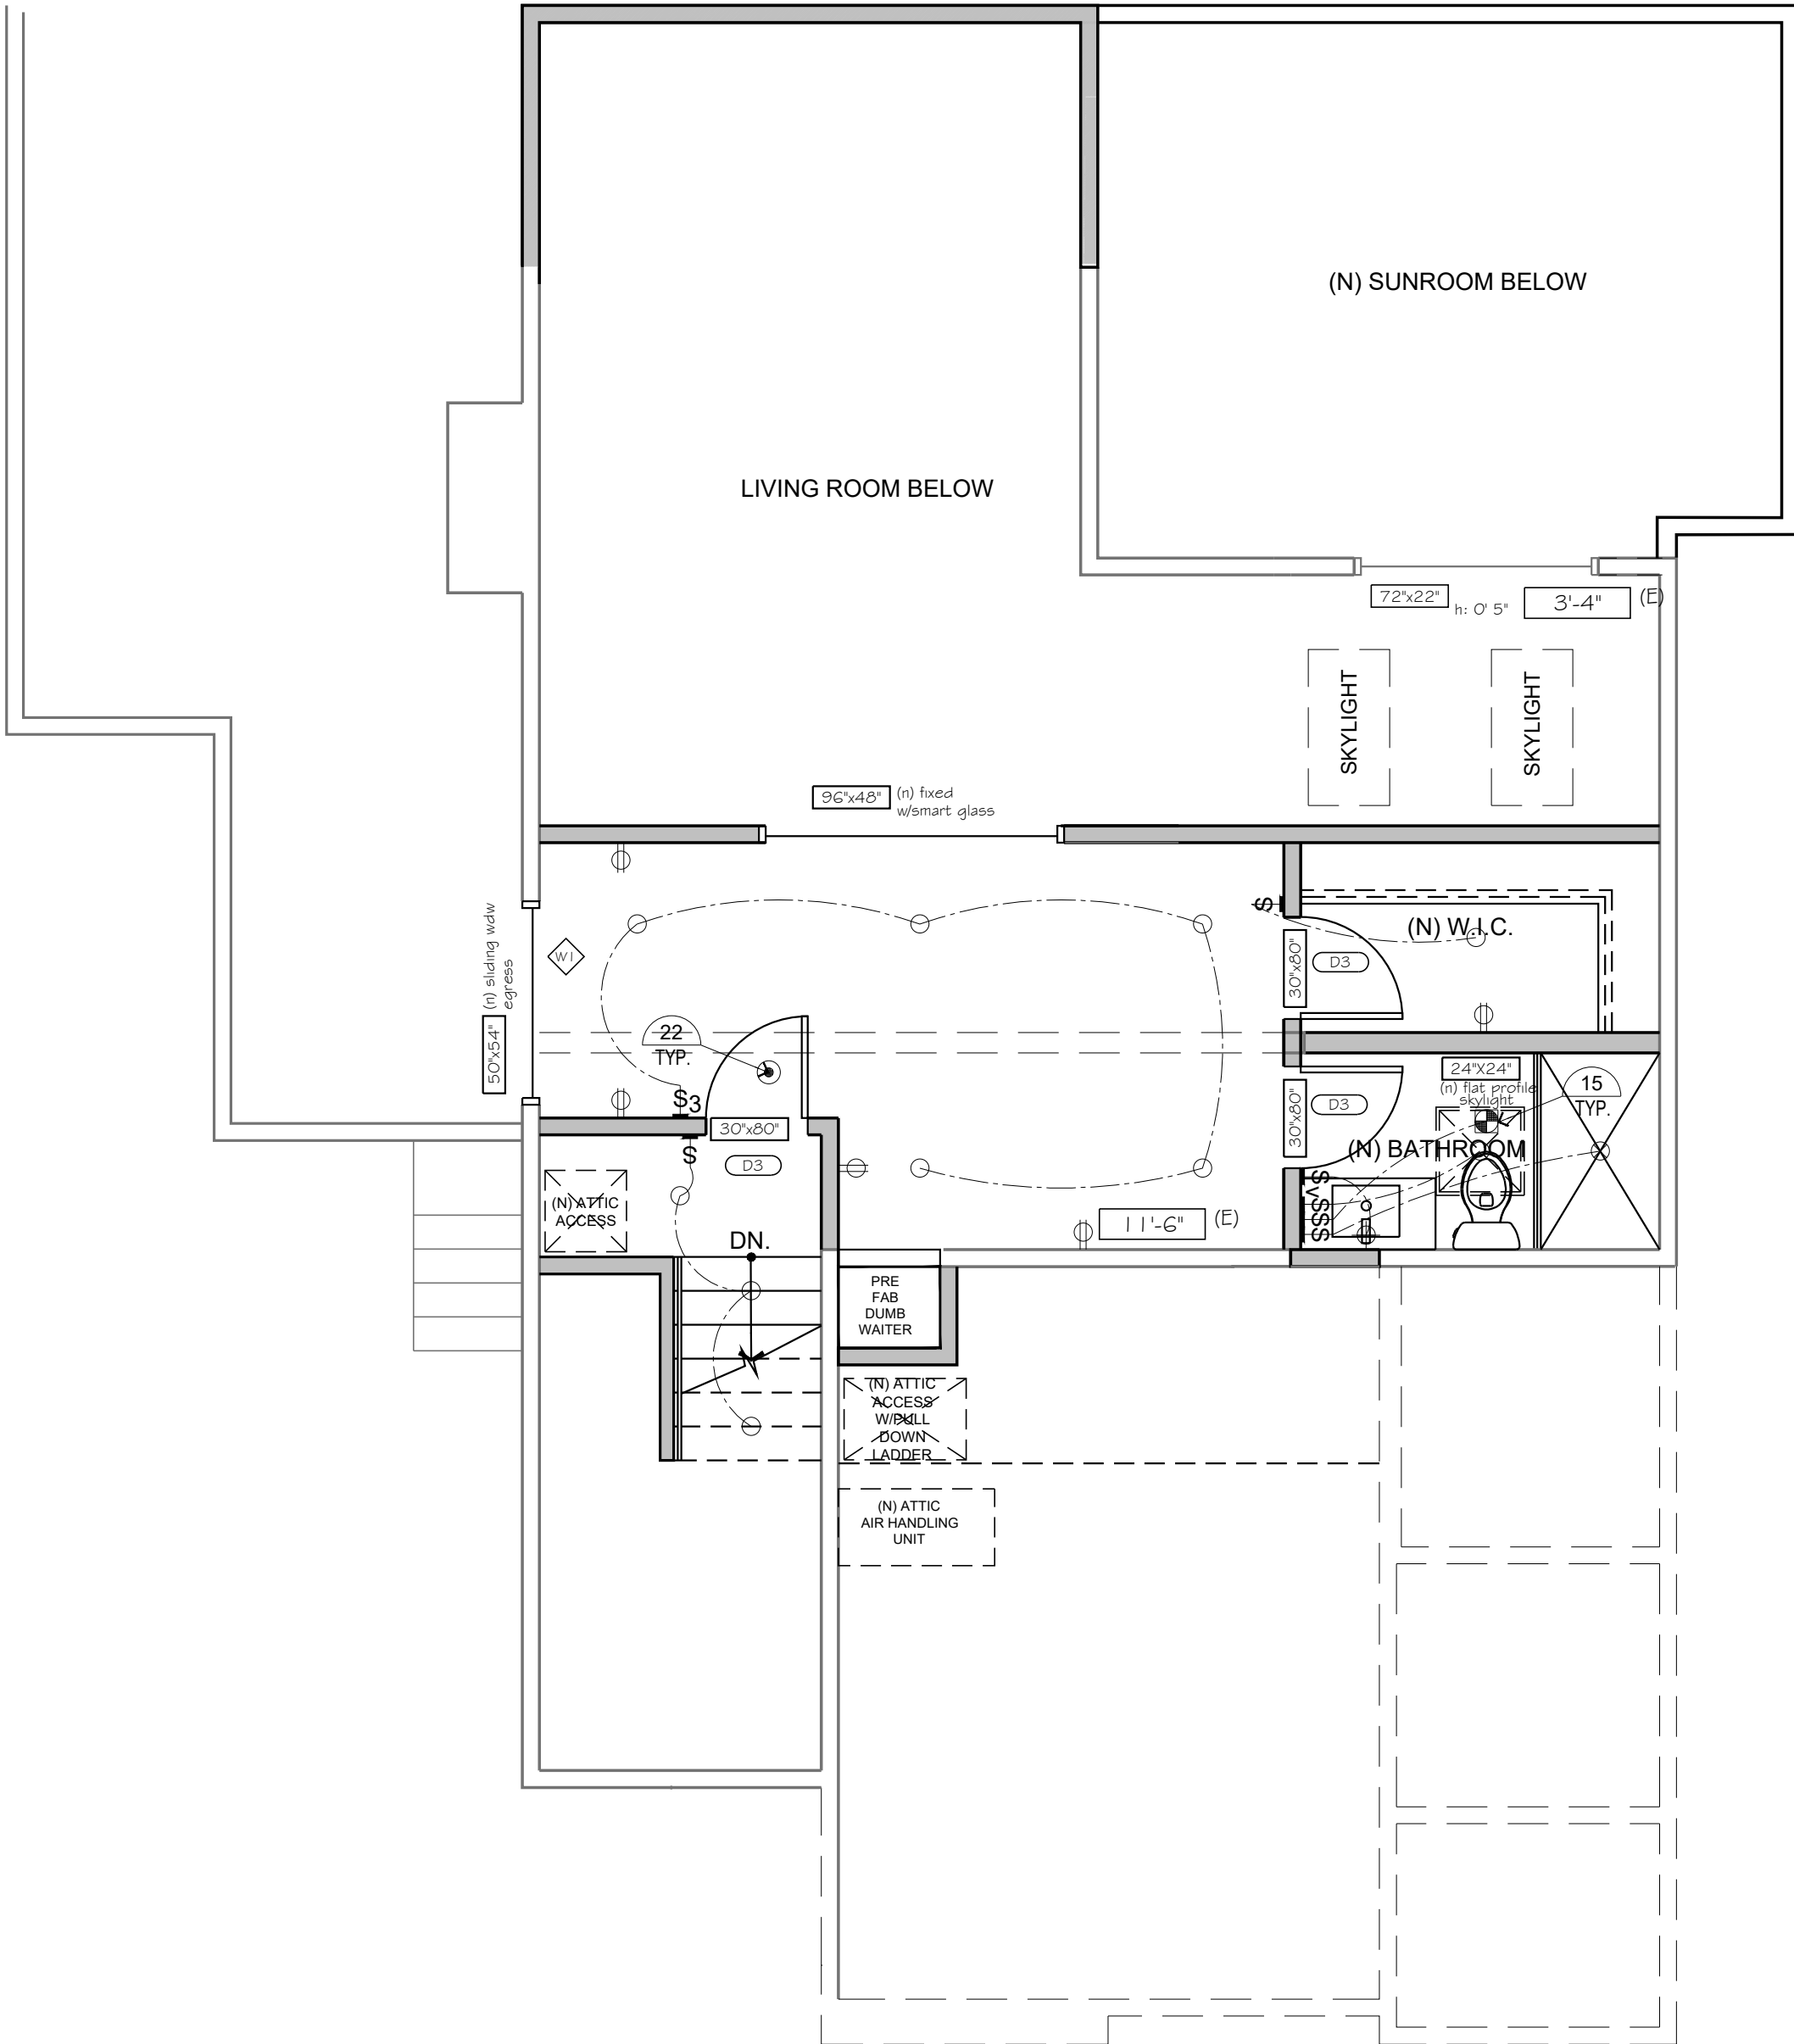

PROPOSED ELECTRICAL THIRD FLOOR PLAN

SCALE: 1/4" = 1'-0" 2

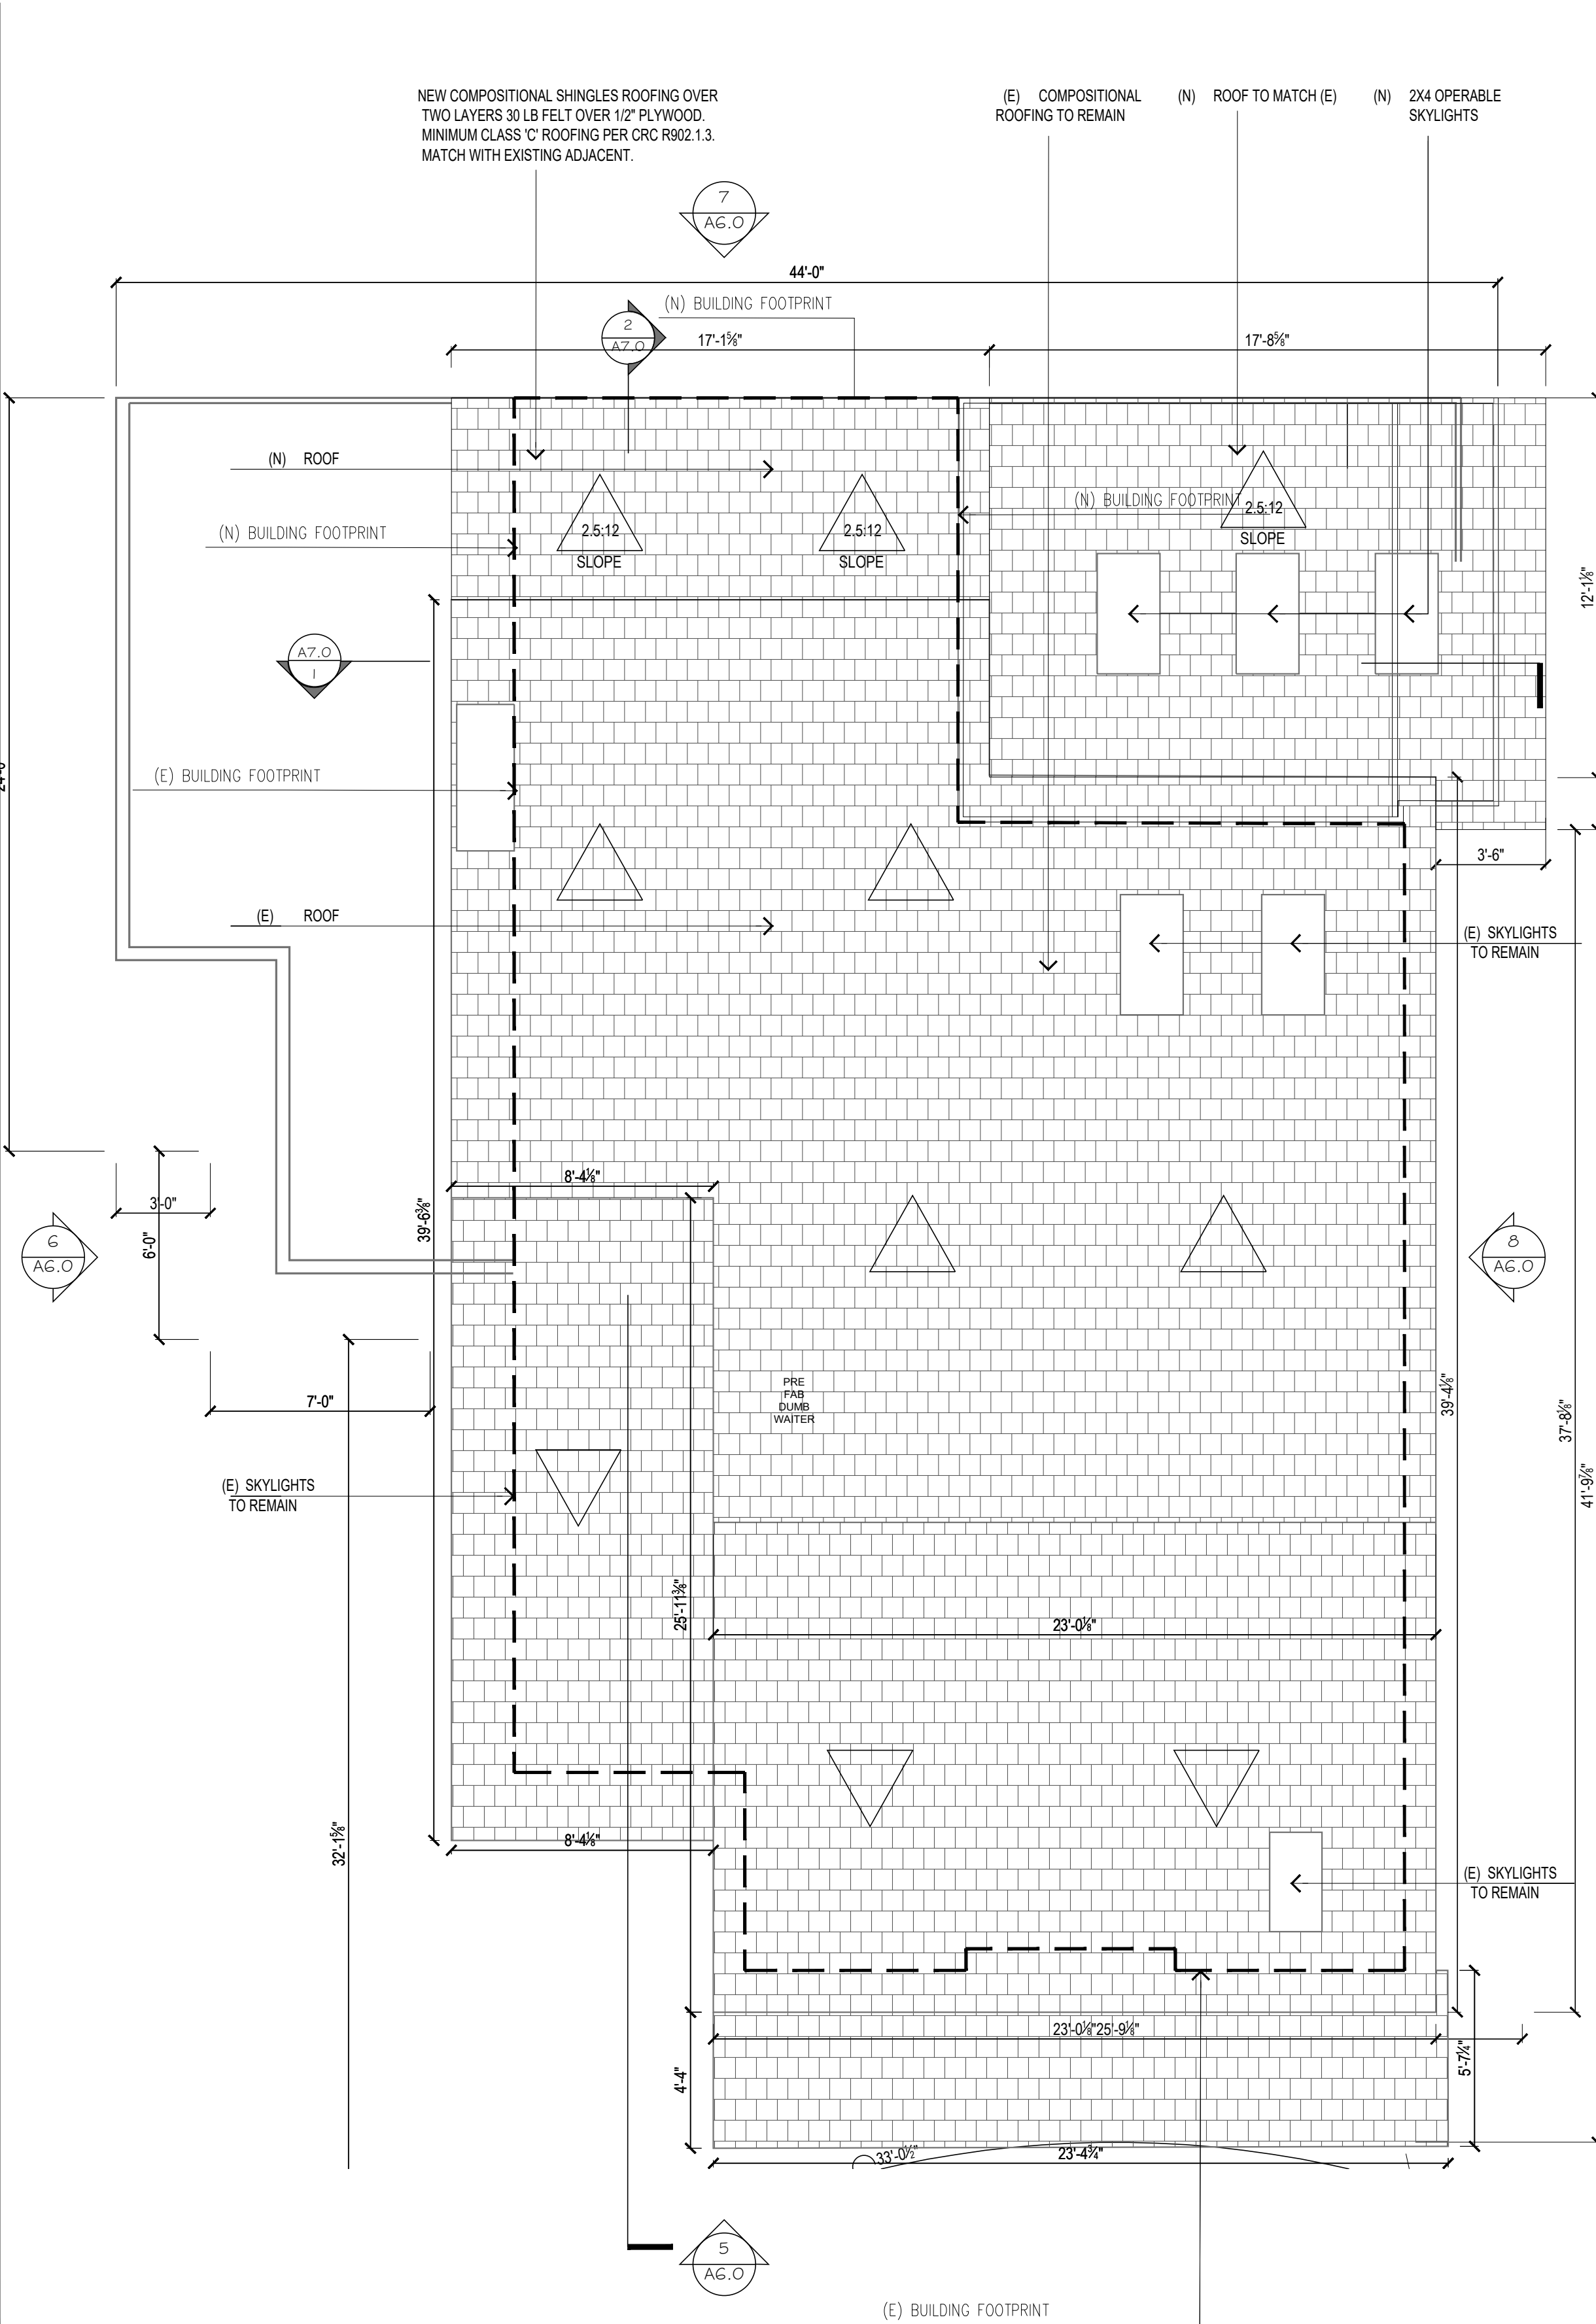

PROPOSED ROOF PLAN



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client review

plan check

bidding

construction

date 4.19.2024

proj num


proj mgr

proj arch

scale AS NOTED

PROPOSED THIRD FLOOR PLANS


sheet number A5.0

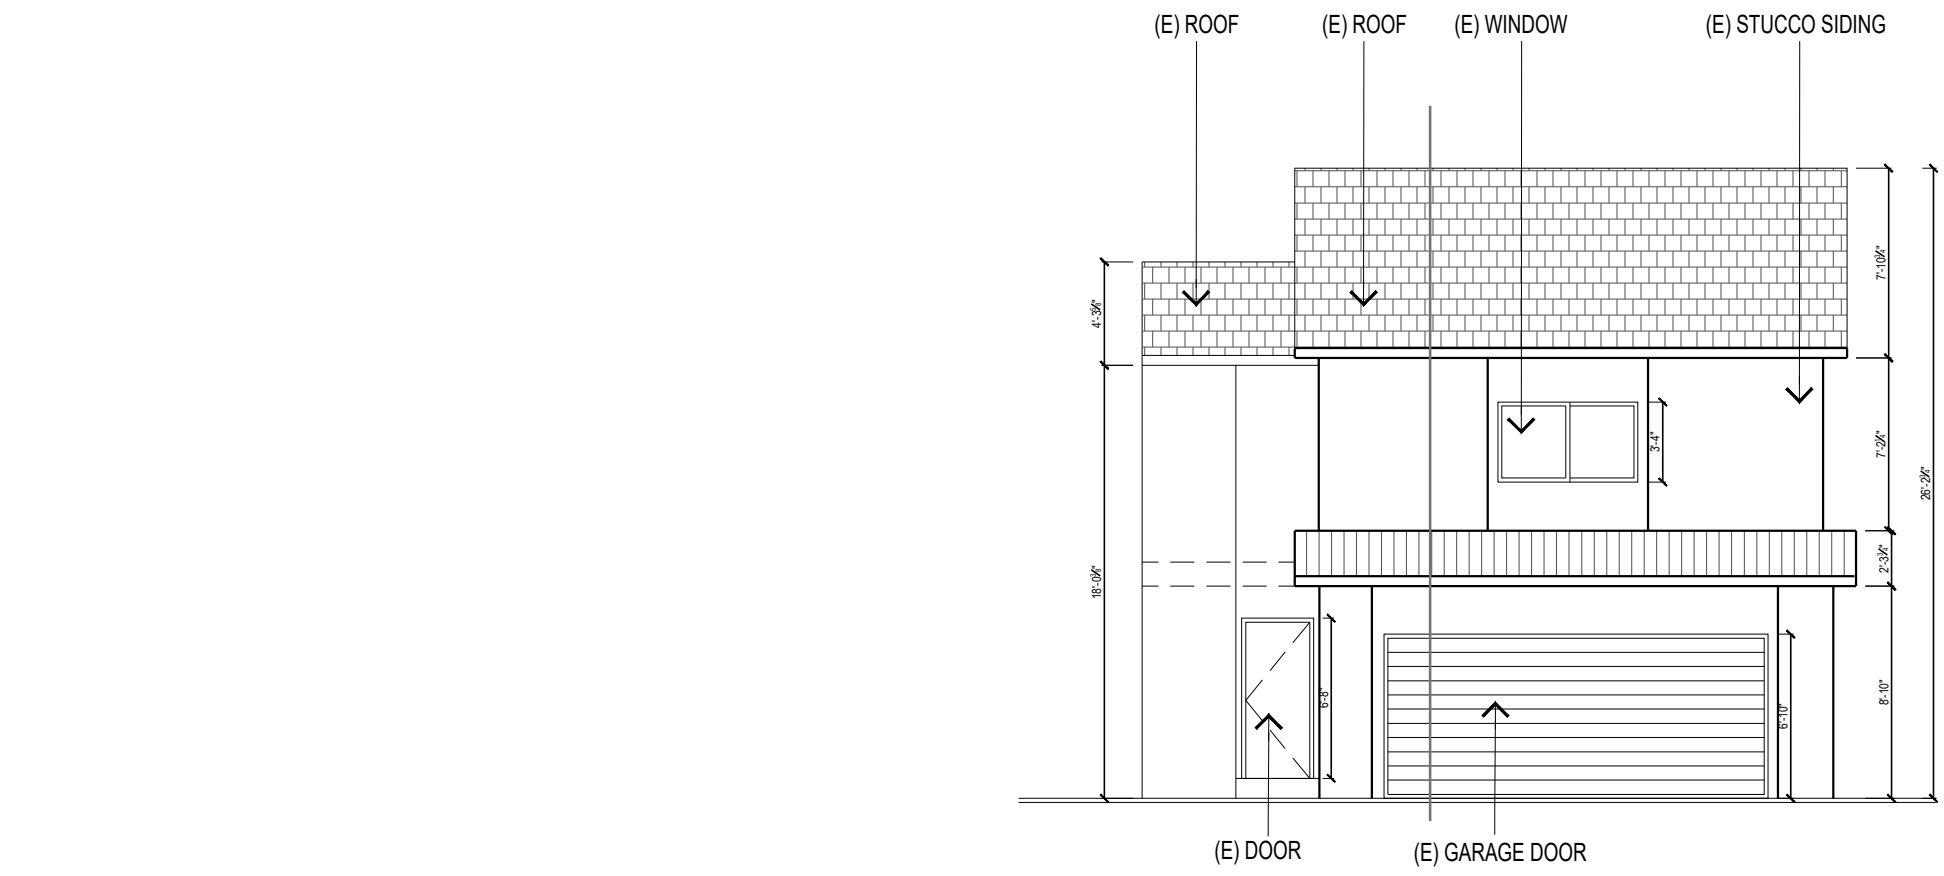

DEMO ELEVATION - WEST (NO CHANGE)

SCALE: 1/8" = 1'-0"


1

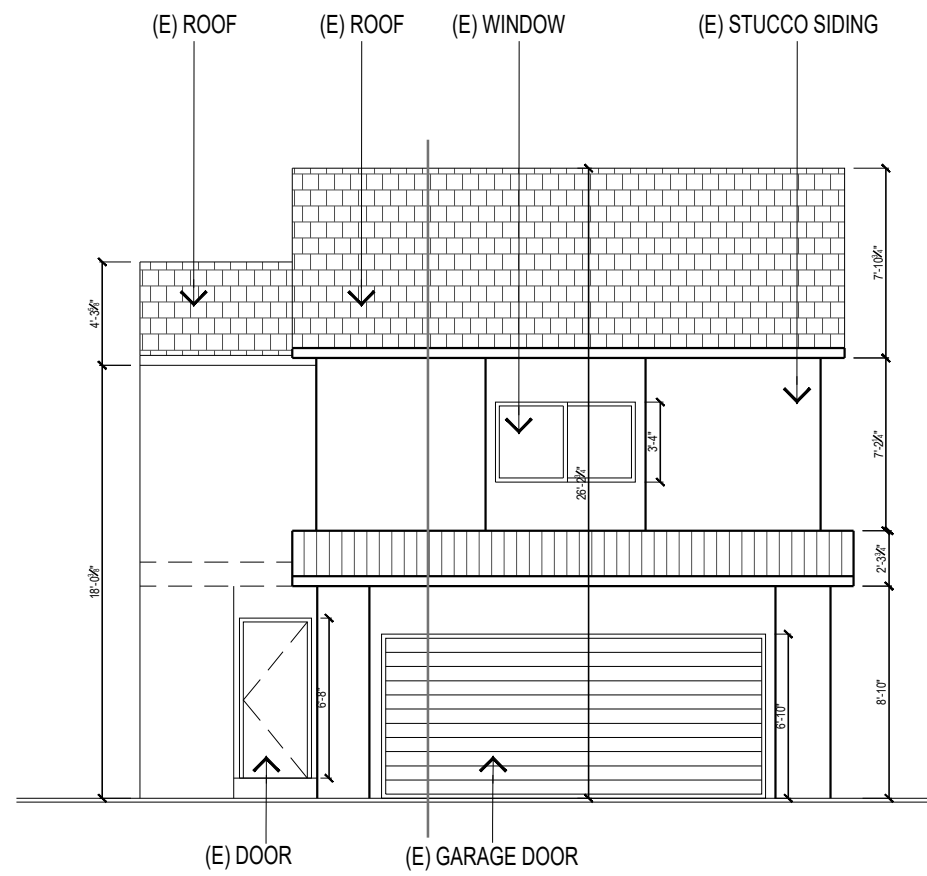

NEW ELEVATION - WEST (NO CHANGE)

SCALE: 1/8" = 1'-0"


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DEMO ELEVATION - NORTH

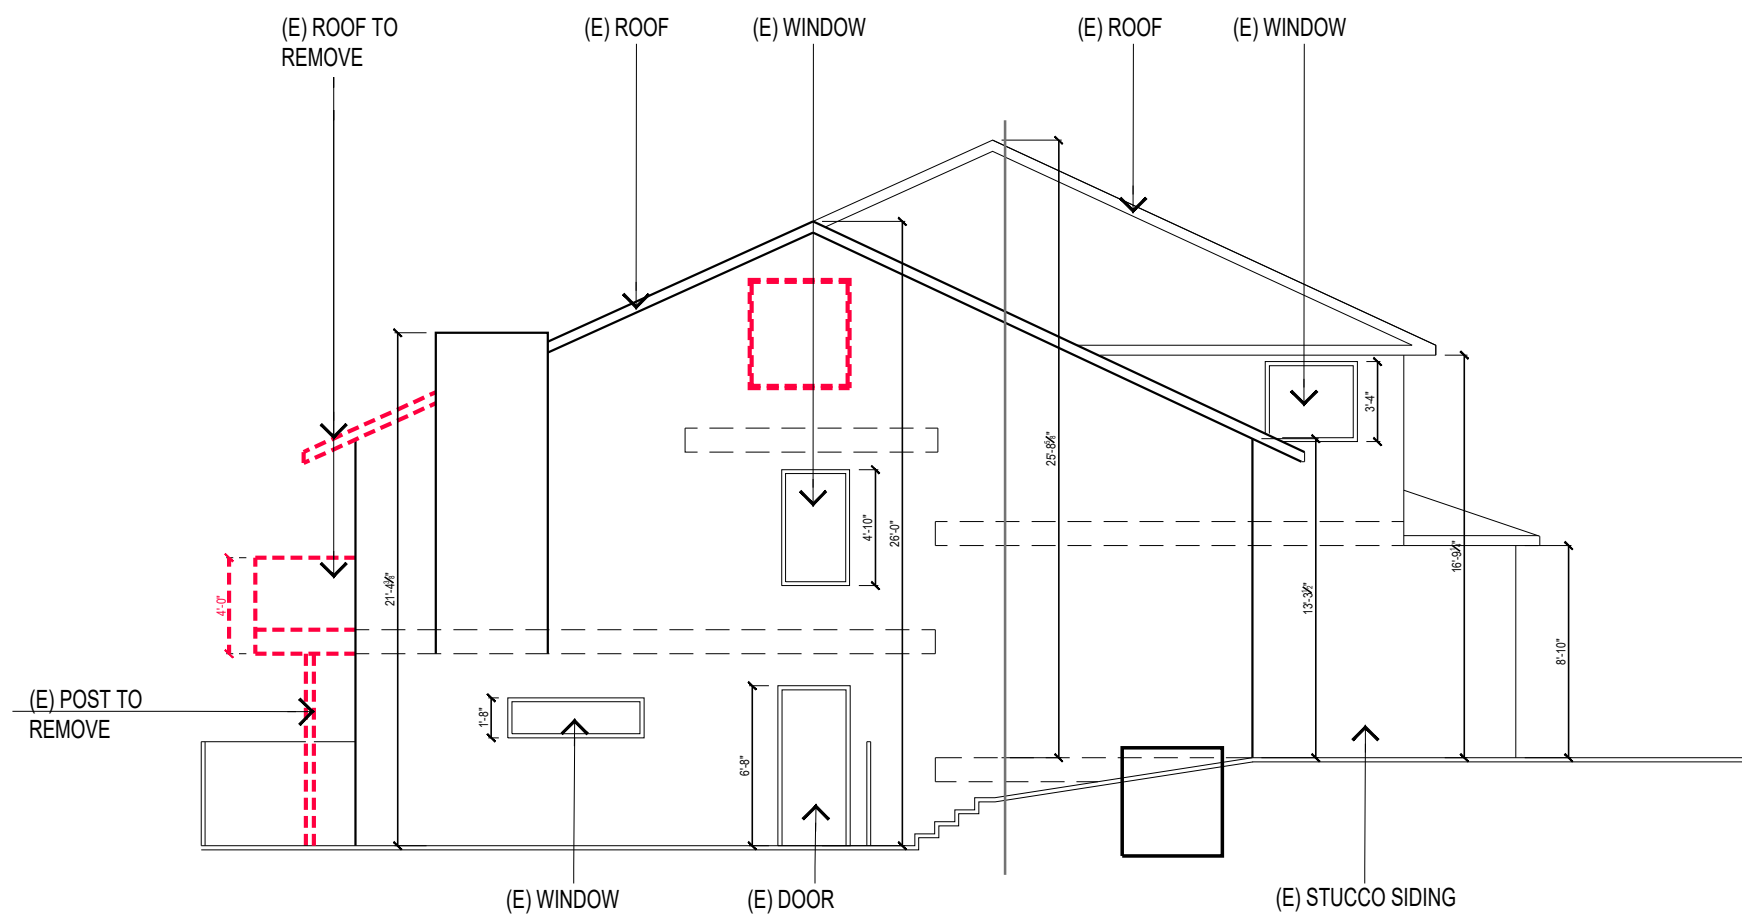SCALE: 1/8" = 1'-0"


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NEW ELEVATION - NORTH

SCALE: 1/8" = 1'-0"


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DEMO ELEVATION - EAST

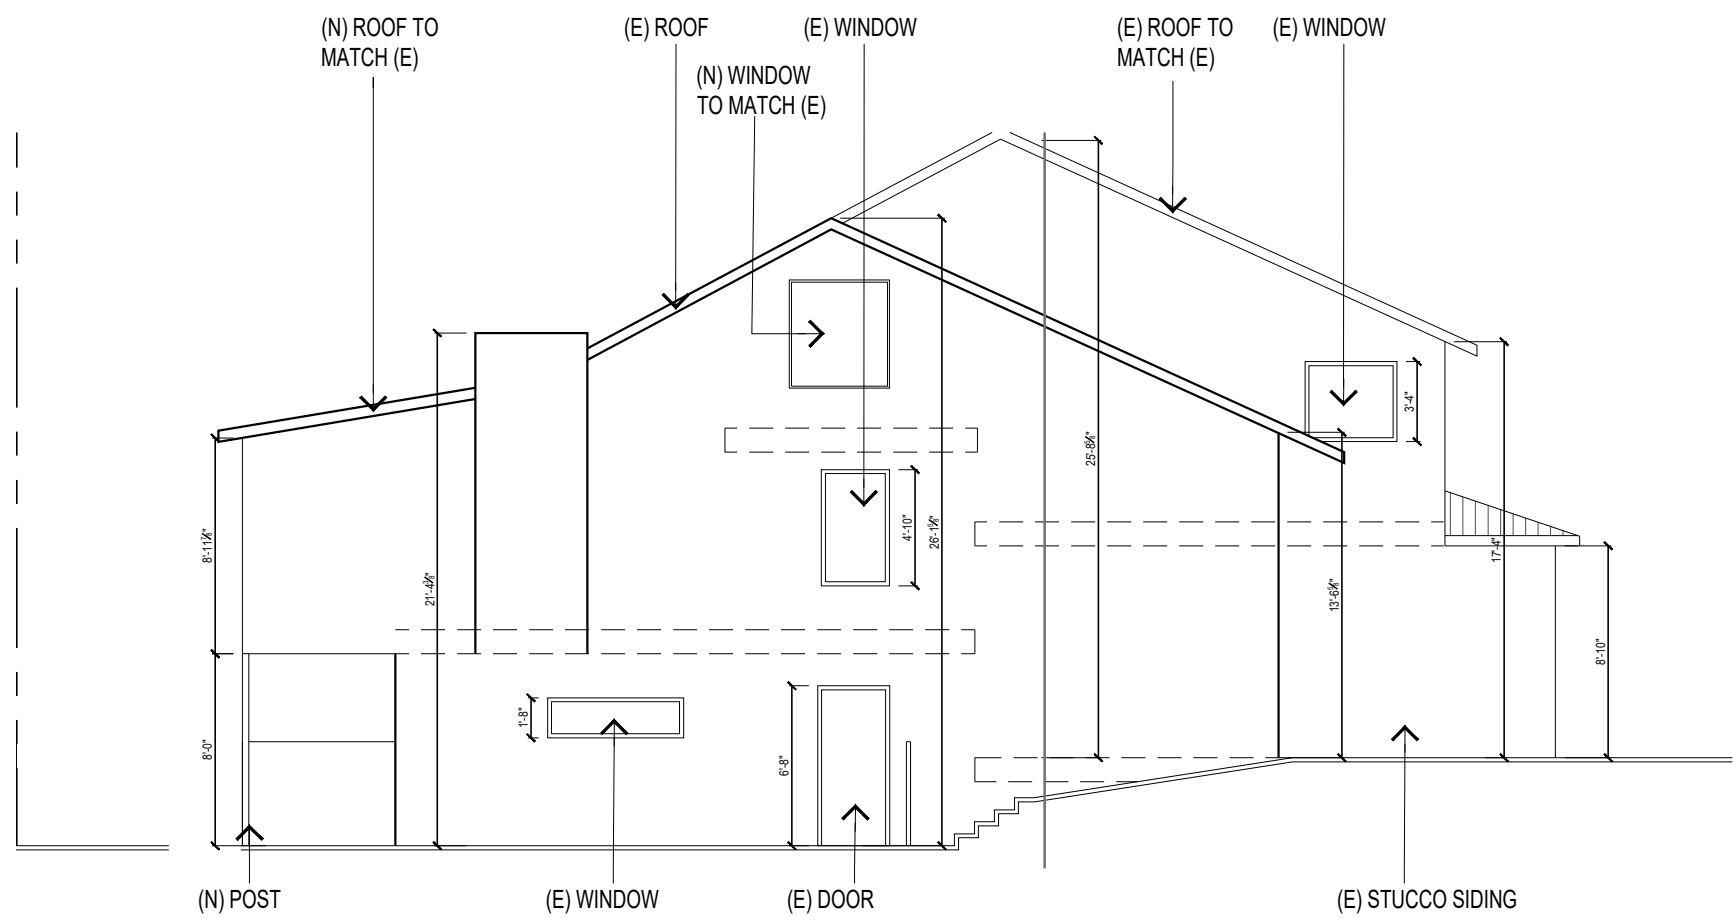SCALE: 1/8" = 1'-0"


3

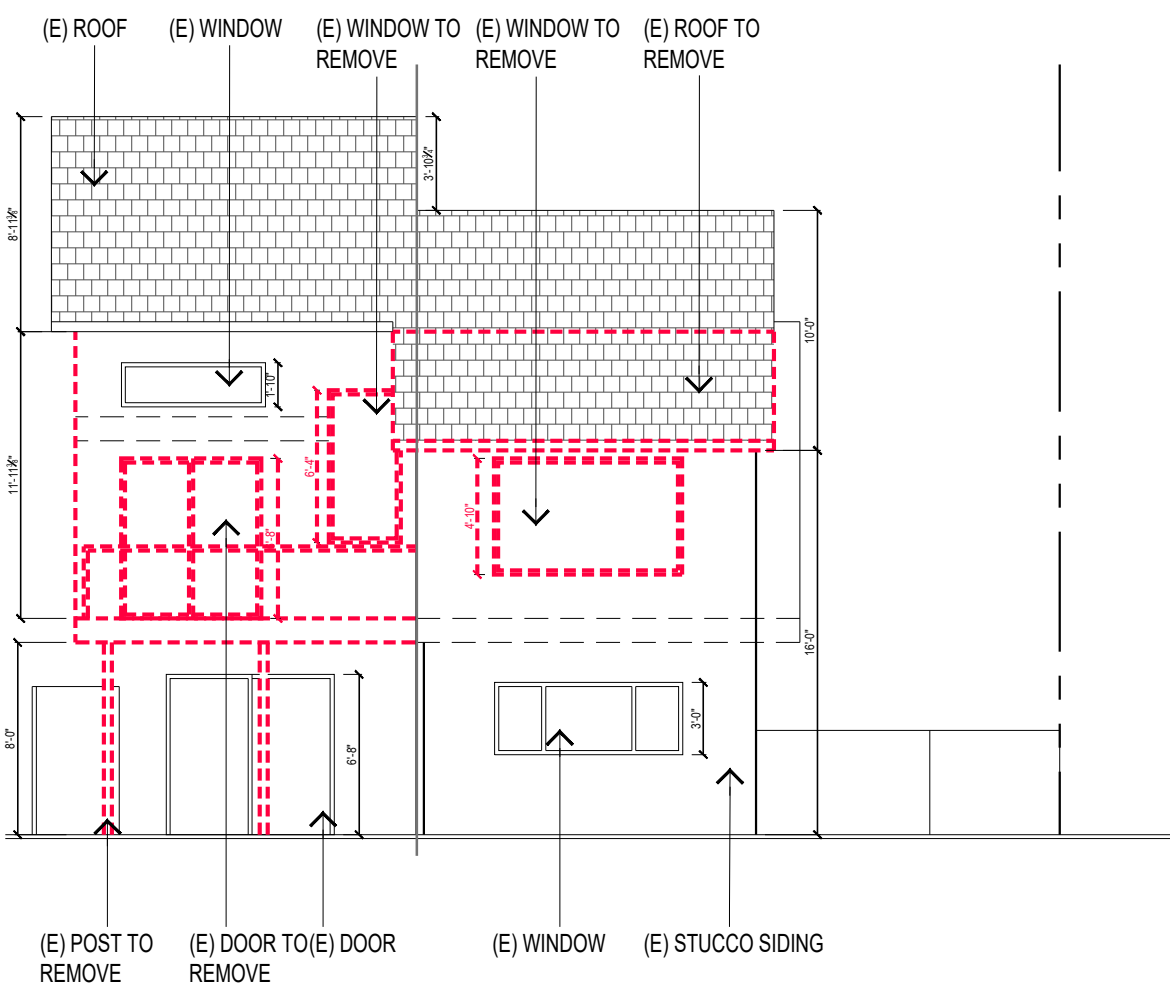

NEW ELEVATION - EAST

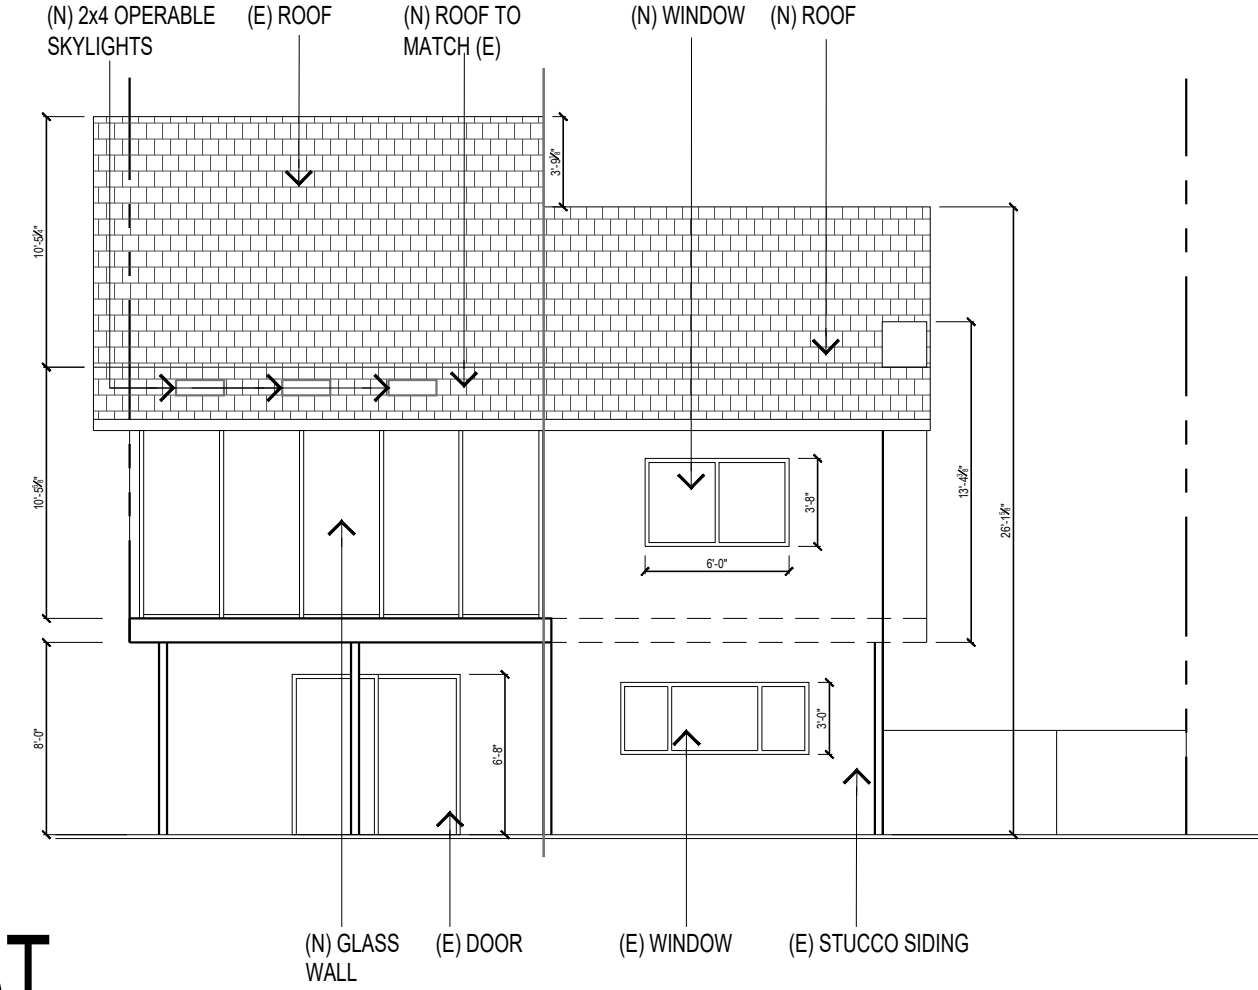SCALE: 1/8" = 1'-0"


7

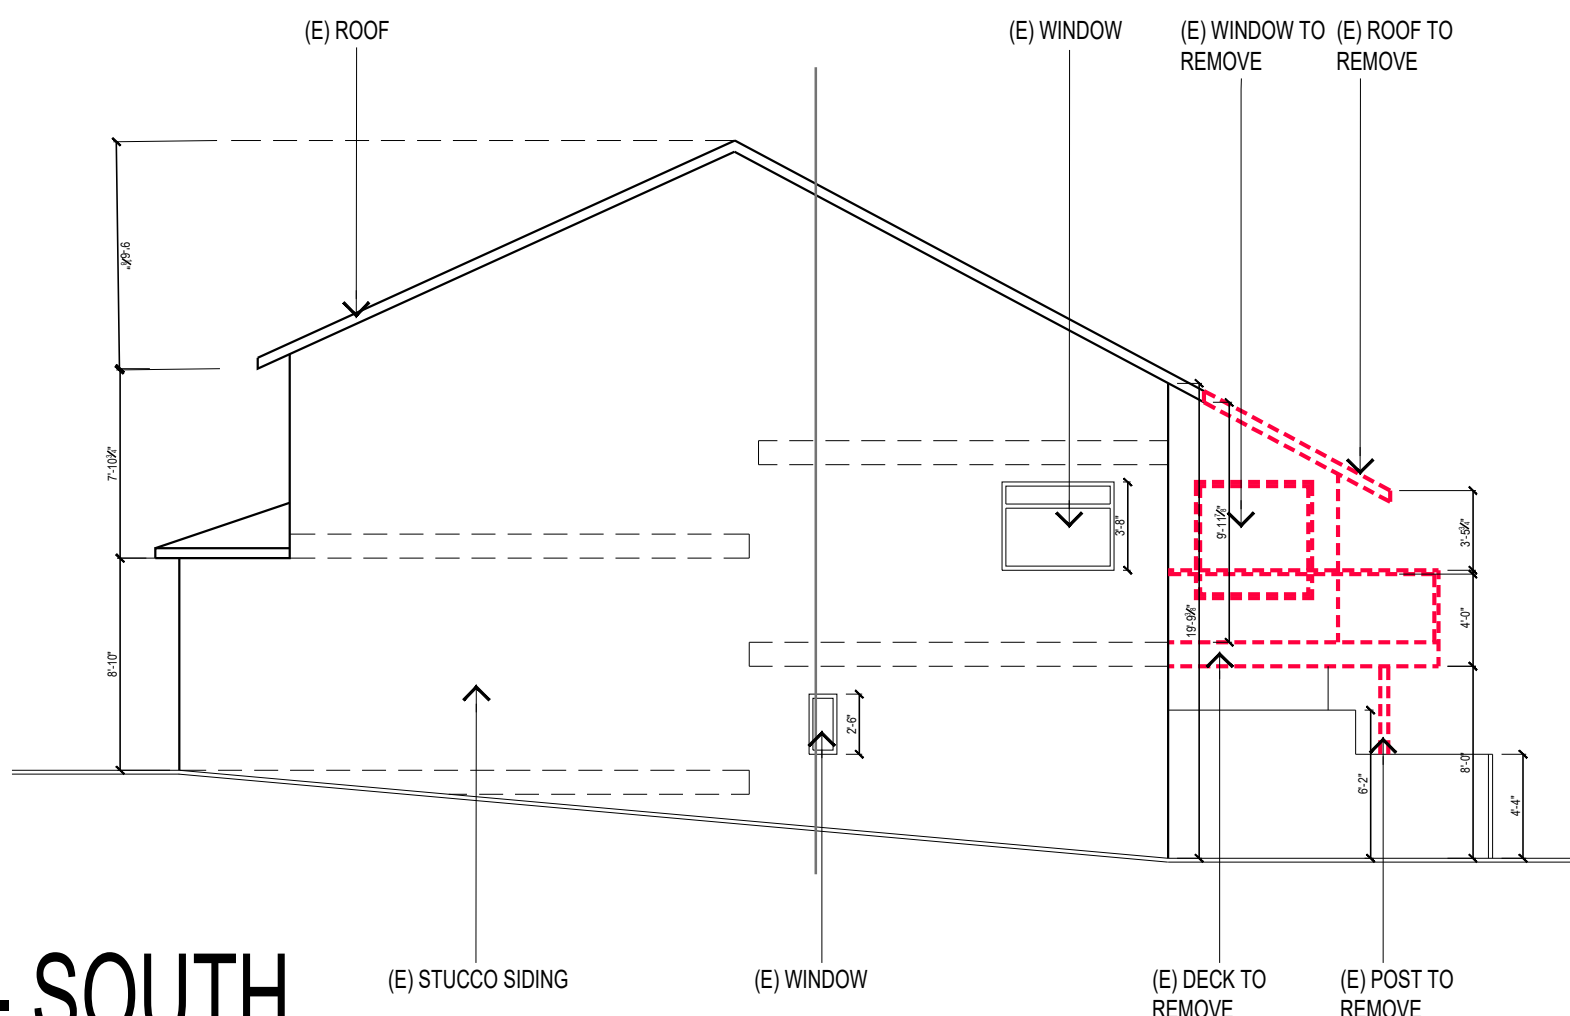

DEMO ELEVATION - SOUTH

SCALE: 1/8" = 1'-0"

4

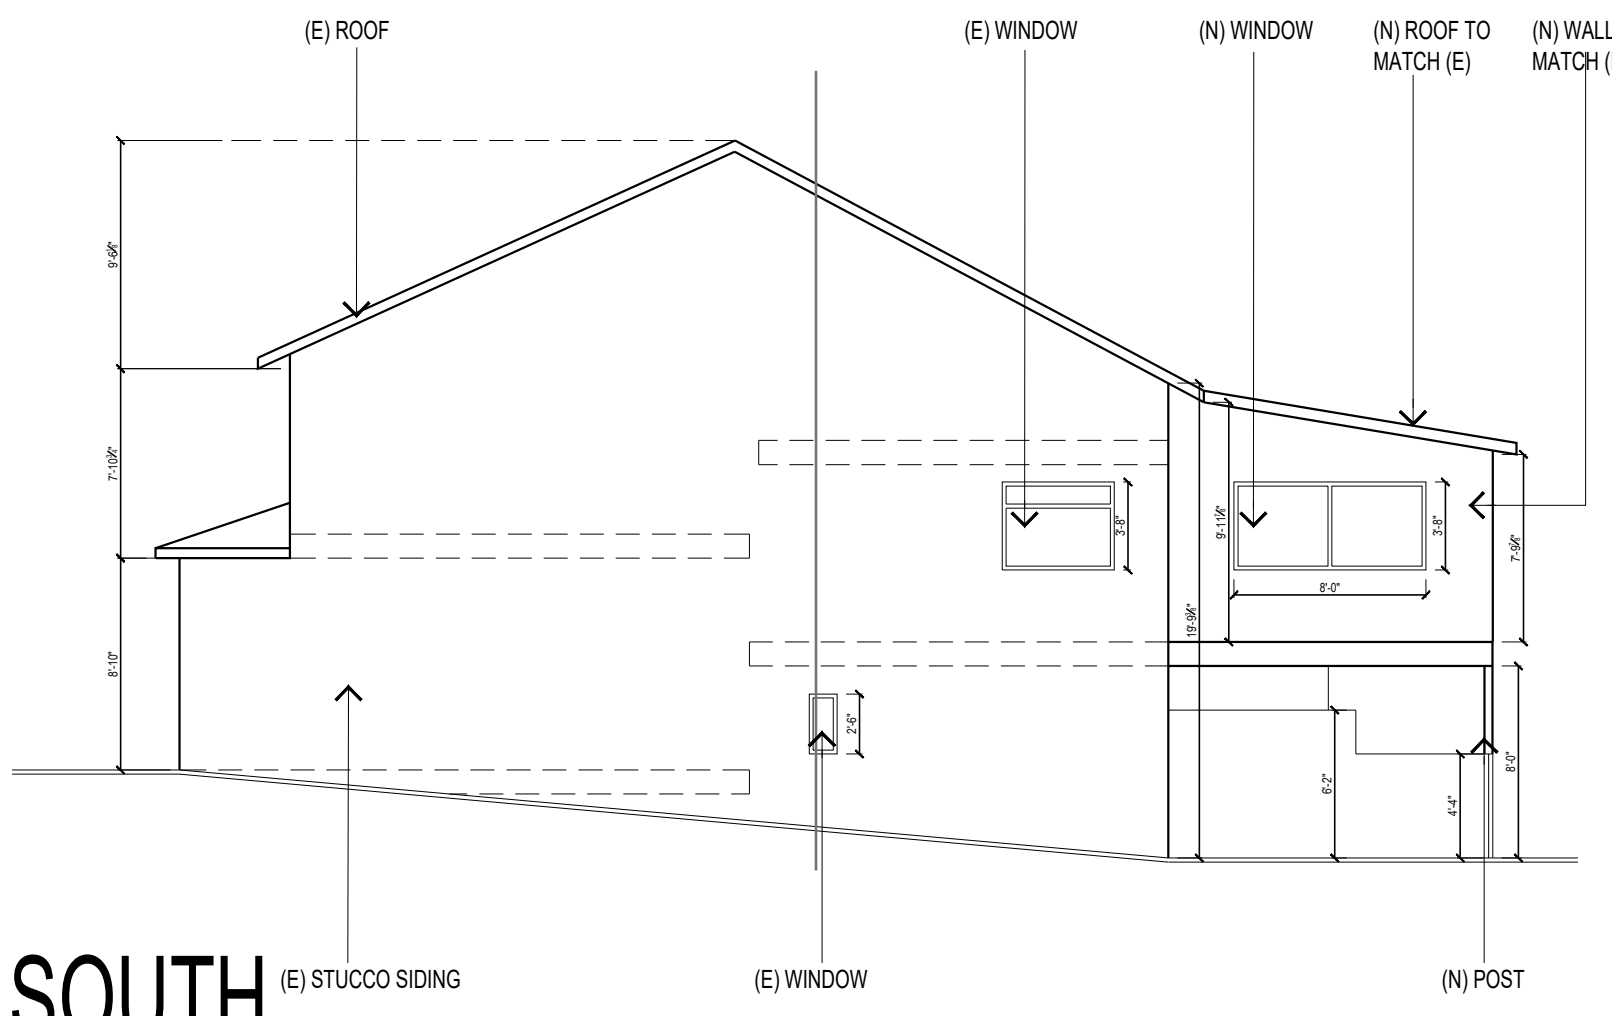

NEW ELEVATION - SOUTH

SCALE: 1/8" = 1'-0"

8



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revision history	date
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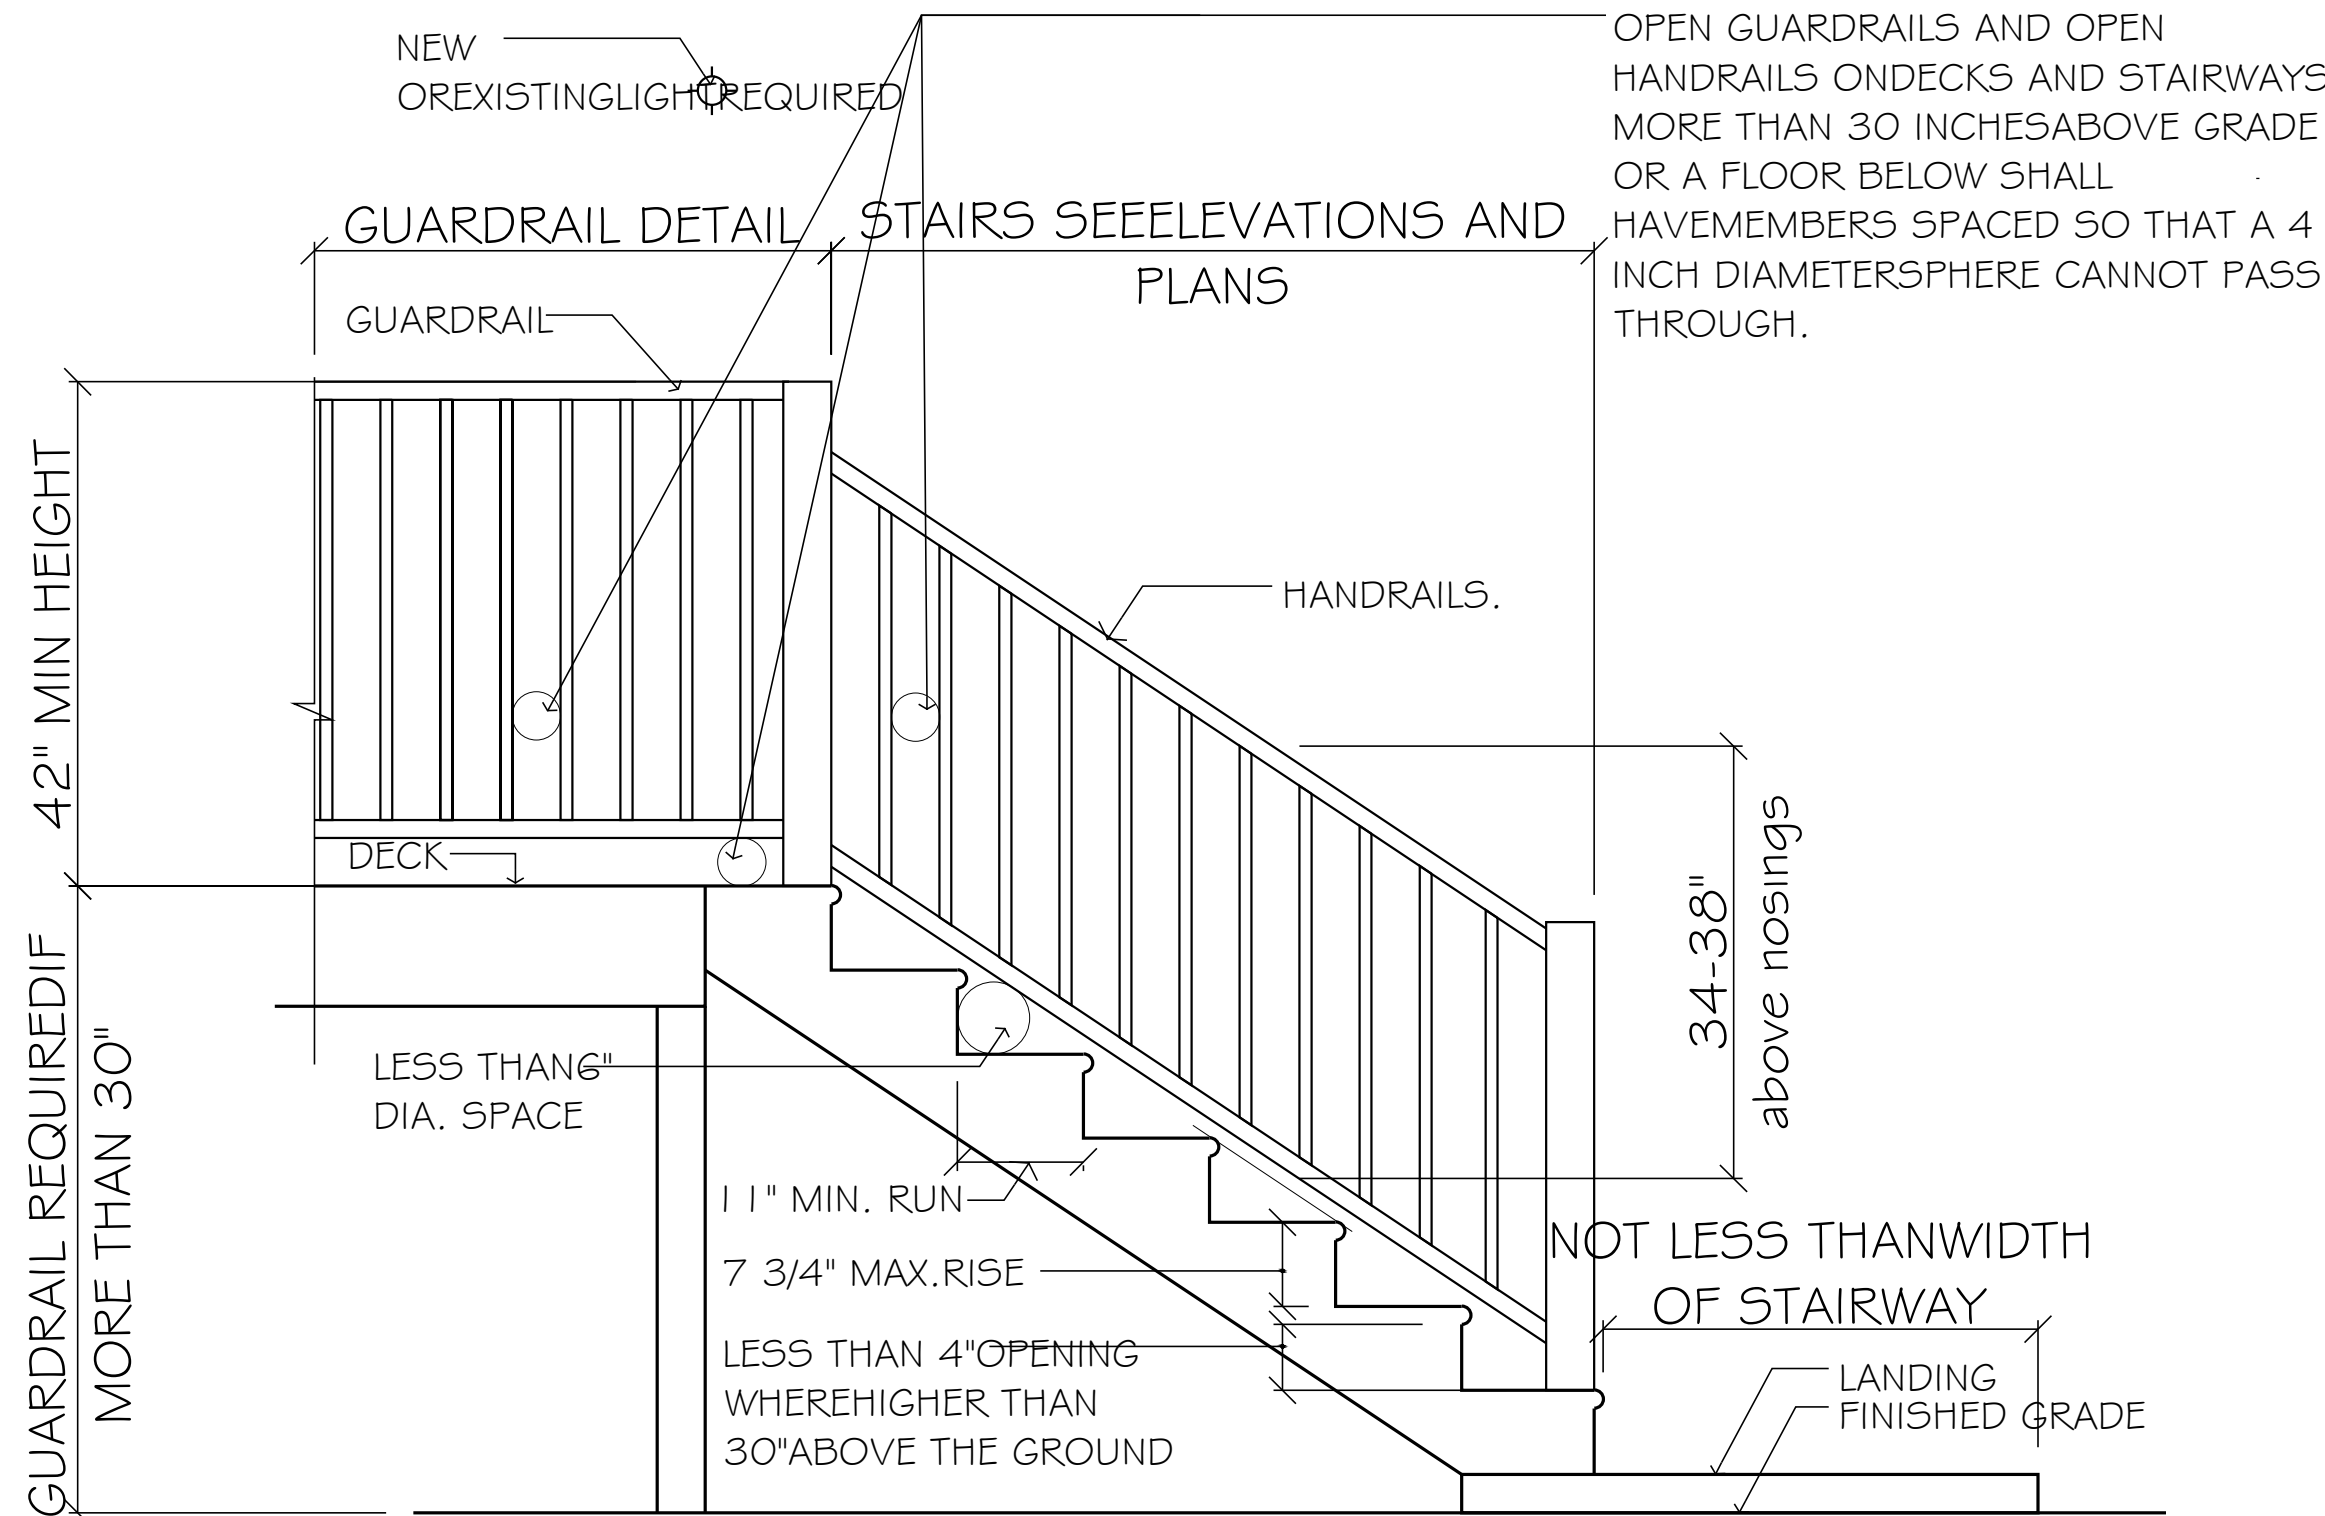
drawing release status	date
4.19.2024	
proj num	
proj mgr	
proj arch	
scale	AS NOTED

DEMO AND NEW ELEVATIONS


sheet number
A6.0

1. STAIR TREADS AND RISERS: STAIR RISER HEIGHTS SHALL BE 7 3/4 INCHES MAXIMUM AND 4 INCHES MINIMUM. STAIR TREAD DEPTHS SHALL BE 10 INCHES MINIMUM. THE RISER HEIGHT SHALL BE MEASURED VERTICALLY BETWEEN THE LEADING EDGES OF THE TREADS. THE TREAD DEPTH SHALL BE MEASURED HORIZONTALLY BETWEEN THE VERTICAL PLANES OF THE FOREMOST PROJECTION OF ADJACENT TREADS AND AT A RIGHT ANGLE TO THE TREAD'S LEADING EDGE. WINDER TREADS SHALL HAVE A MINIMUM TREAD DEPTH OF 10 INCHES MEASURED AT A RIGHT ANGLE TO THE TREAD'S LEADING EDGE AT THE WALKLINE. WINDER TREADS SHALL HAVE A MINIMUM TREAD DEPTH OF 6" AT ANY POINT IN THE CLEAR WIDTH OF THE STAIR.
2. STAIR LANDING: STAIR LANDINGS SHALL BE AT OR LANDING AT THE TOP AND BOTTOM OF EACH STAIRWAY. THE WIDTH OF THE LANDINGS SHALL NOT BE LESS THAN THE WIDTH OF STAIRWAYS THEY SERVE. EVERY LANDING SHALL HAVE A MINIMUM DIMENSION OF 36" MEASURED IN THE DIRECTION OF TRAVEL.
3. ENCLOSURES UNDER STAIRWAYS: THE WALLS AND CEILING WITHIN ENCLOSED USABLE SPACES UNDER ENCLOSED AND UNENCLOSED STAIR -WAYS SHALL BE PROTECTED BY AN ENCLOSED SPACE WITH 3/4" INCH OPSION BOARD. THERE SHALL BE NO ENCLOSED USABLE SPACE UNDER EXTERIOR EXIT STAIRWAYS UNLESS THE SPACE IS COMPLETELY EN -CLOSED IN 1-HOUR FIRE-RESISTIVE RATED CONSTRUCTION. THE OPEN SPACE UNDER EXTERIOR STAIRWAYS SHALL NOT BE USED FOR ANY PURPOSE.
4. HANDRAIL HEIGHT: HANDRAILS SHALL BE MEASURED ABOVE STAIR TREAD NOSING, OR FINISH SURFACE RAMP SLOPE SHALL BE UNIFORM, NOT LESS THAN 34 INCHES AND NOT MORE THAN 38 INCHES.
5. HANDRAIL GRIP-SIZE: HANDRAILS WITH A CIRCULAR CROSS- SECTION SHALL AN OUTSIDE DIAMETER OF AT LEAST 1.25 INCHES AND NOT GREATER THAN 2 INCHES OR SHALL PROVIDE EQUIVALENT GRIP SIZE. IF THE HANDRAIL IS A RECTANGLE, IT SHALL BE AT LEAST 1 1/2 INCHES BY AT LEAST 4 INCHES AND NOT GREATER THAN 6.25 INCHES WITH A MAXIMUM CROSS-SECTION DIMENSION OF 2.25 INCHES. EDGES SHALL HAVE A MINIMUM RADIUS OF 0.01 INCH.


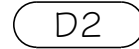
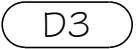



1. CONFORM TO 2019 CCR §301.5. HANDRAILS AND GUARDS SHALL BE DESIGNED
2. TO RESIST A CONCENTRATED LOAD OF 200LB/IN ALONG ANY DIRECTION.
[CCR §301.5]
3. GUARDRAILS ARE REQUIRED ALONG OPEN SIDES OF STAIRWAYS, LANDINGS,
4. BALCONIES, PORCHES, DECKS, FLOOR OPENINGS, RAMPS, AND ROOFS USED FOR
5. OTHER THAN SERVICE OF THE BUILDING, WHICH ARE MORE THAN 30" ABOVE
6. GRADE OR FLOOR BELOW.
7. GUARDRAILS SHALL HAVE A 42" MINIMUM HEIGHT, 42" HIGH ALONG OPEN SIDES
8. OF STAIRWAYS.
9. GUARDRAILS SHALL BE ABLE TO WITHSTAND A LOAD OF 20 POUNDS PER LINEAL
10. FOOT APPLIED HORIZONTALLY AT THE TOP OF THE GUARDRAIL.
11. INTERMEDIATE RAILS, PANELS OR FILLERS, AND THEIR CONNECTIONS, SHALL BE
12. CAPABLE OF WITHSTANDING A LOAD OF 25 POUNDS PER SQUARE FOOT
13. APPLIED AT RIGHT ANGLES TO THE GUARDRAIL.
14. GUARDRAILS SHALL BE DESIGNED SO THAT A 6" DIAMETER SPHERE CANNOT
15. PASS THROUGH THE TRIANGULAR SPACE FORMED BY THE BOTTOM OF THE
16. RAIL, THE RISER AND THE TREAD.
17. BALUSTERS ON A HANDRAIL OR A GUARDRAIL SHALL BE SO SPACED SO THAT
18. A 4" SPHERE CANNOT PASS THROUGH.

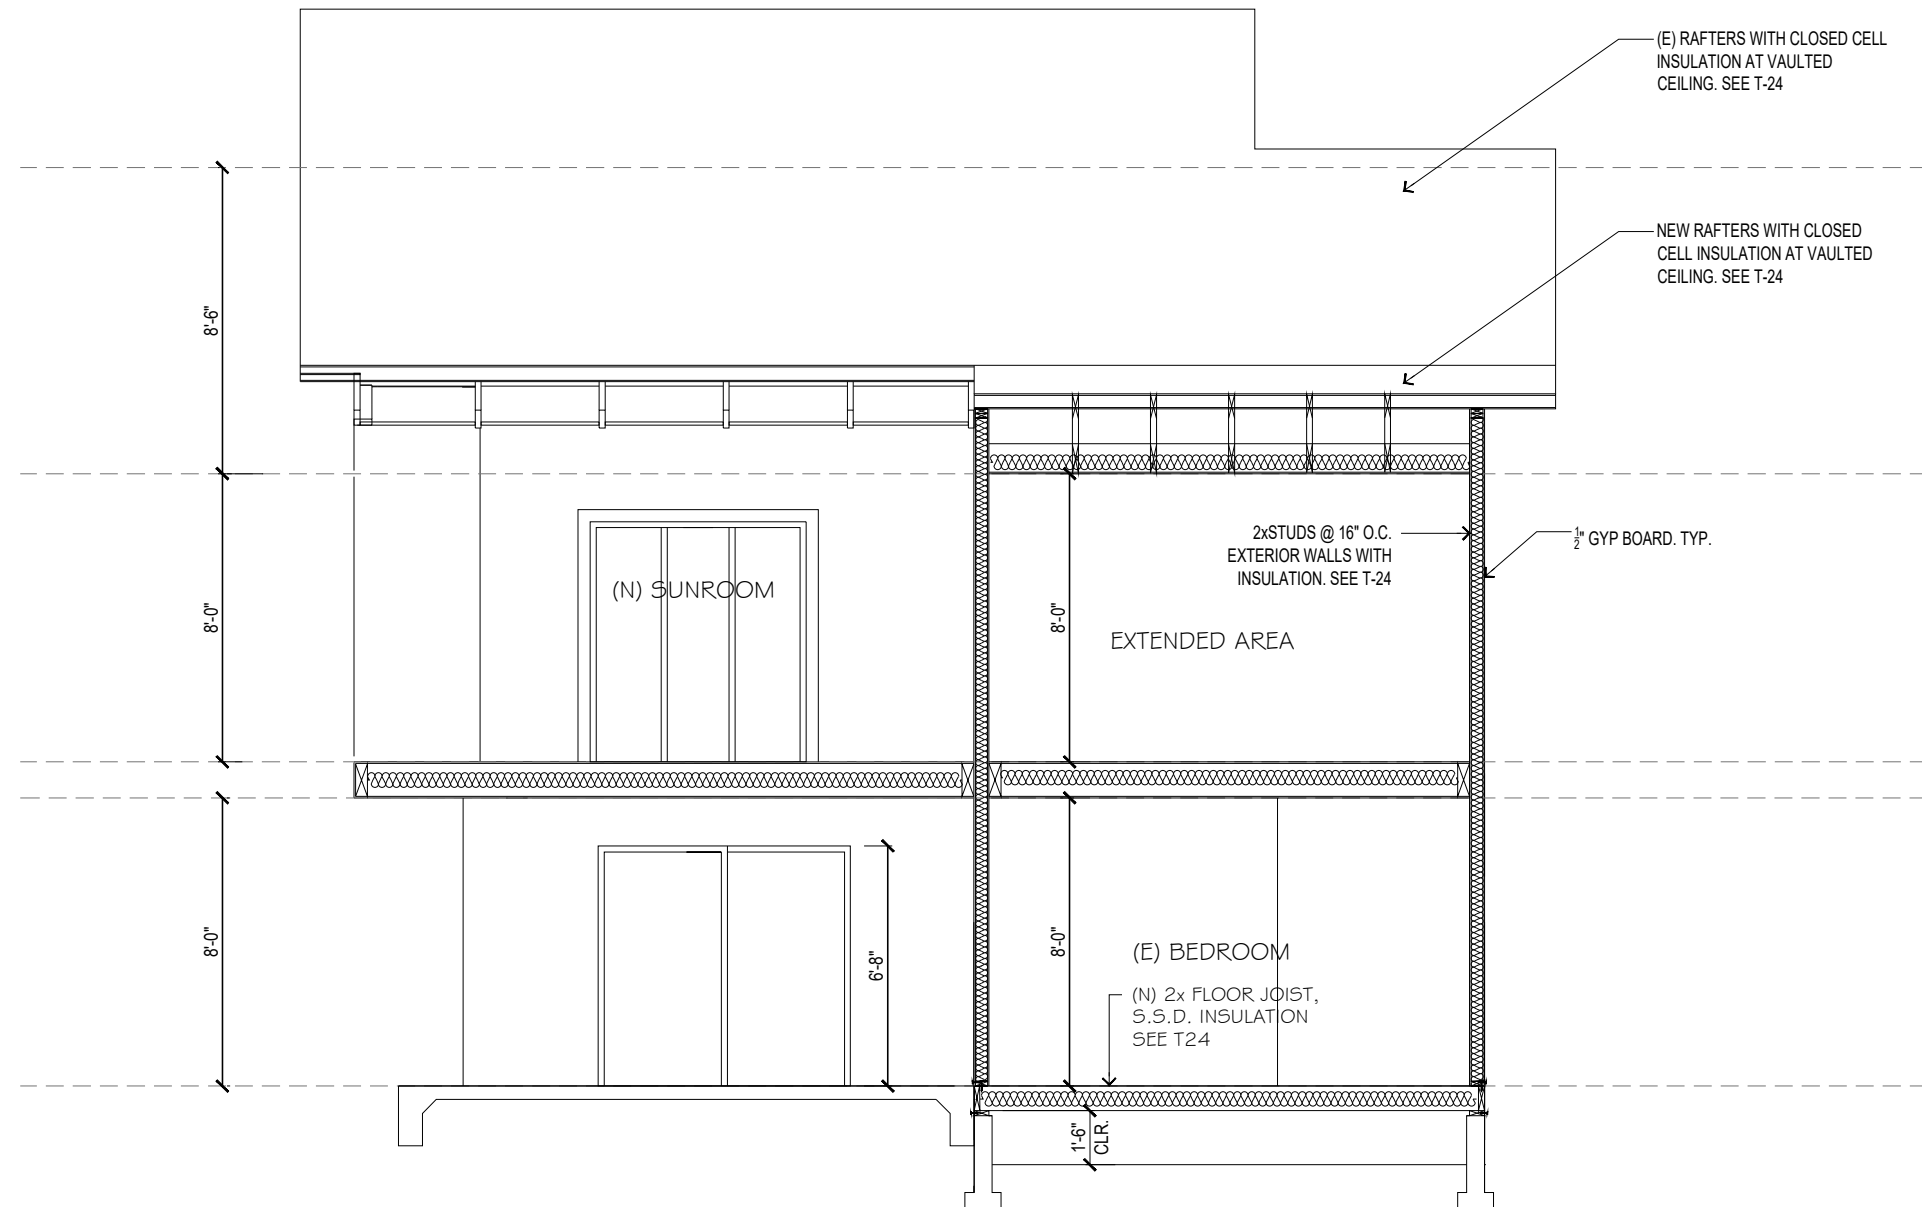


SCALE: 3/4" = 1'-0" 3



SCALE: 3/16" = 1'-0" 1

DOOR AND WINDOW SCHEDULE						
MARK						
WIDTH	9' - 0"	2' - 8"	2' - 6"	6' - 0"	6' - 0"	8' - 0"
HEIGHT	6' - 8"	6' - 8"	6' - 8"	6' - 8"	3' - 8"	3' - 8"
LOCATION	(N) SUNROOM	RECONF LAUNDRT RM.	(E) BEDROOM, (N) BEDROOM, (N) BATHROOM, (N) W.I.C.	(N) CLOSET	(N) BEDROOM	(N) SUNROOM
QUANTITY	2	1	8	1	1	2
COMMENTS	FOLDING TEMPERED DOOR	SINGLE PANEL SOLID DOOR		SLIDING DOOR	SLIDING EGRESS WINDOW	SLIDING EGRESS WINDOW

SCALE: 3/8" = 1'-0" | 4

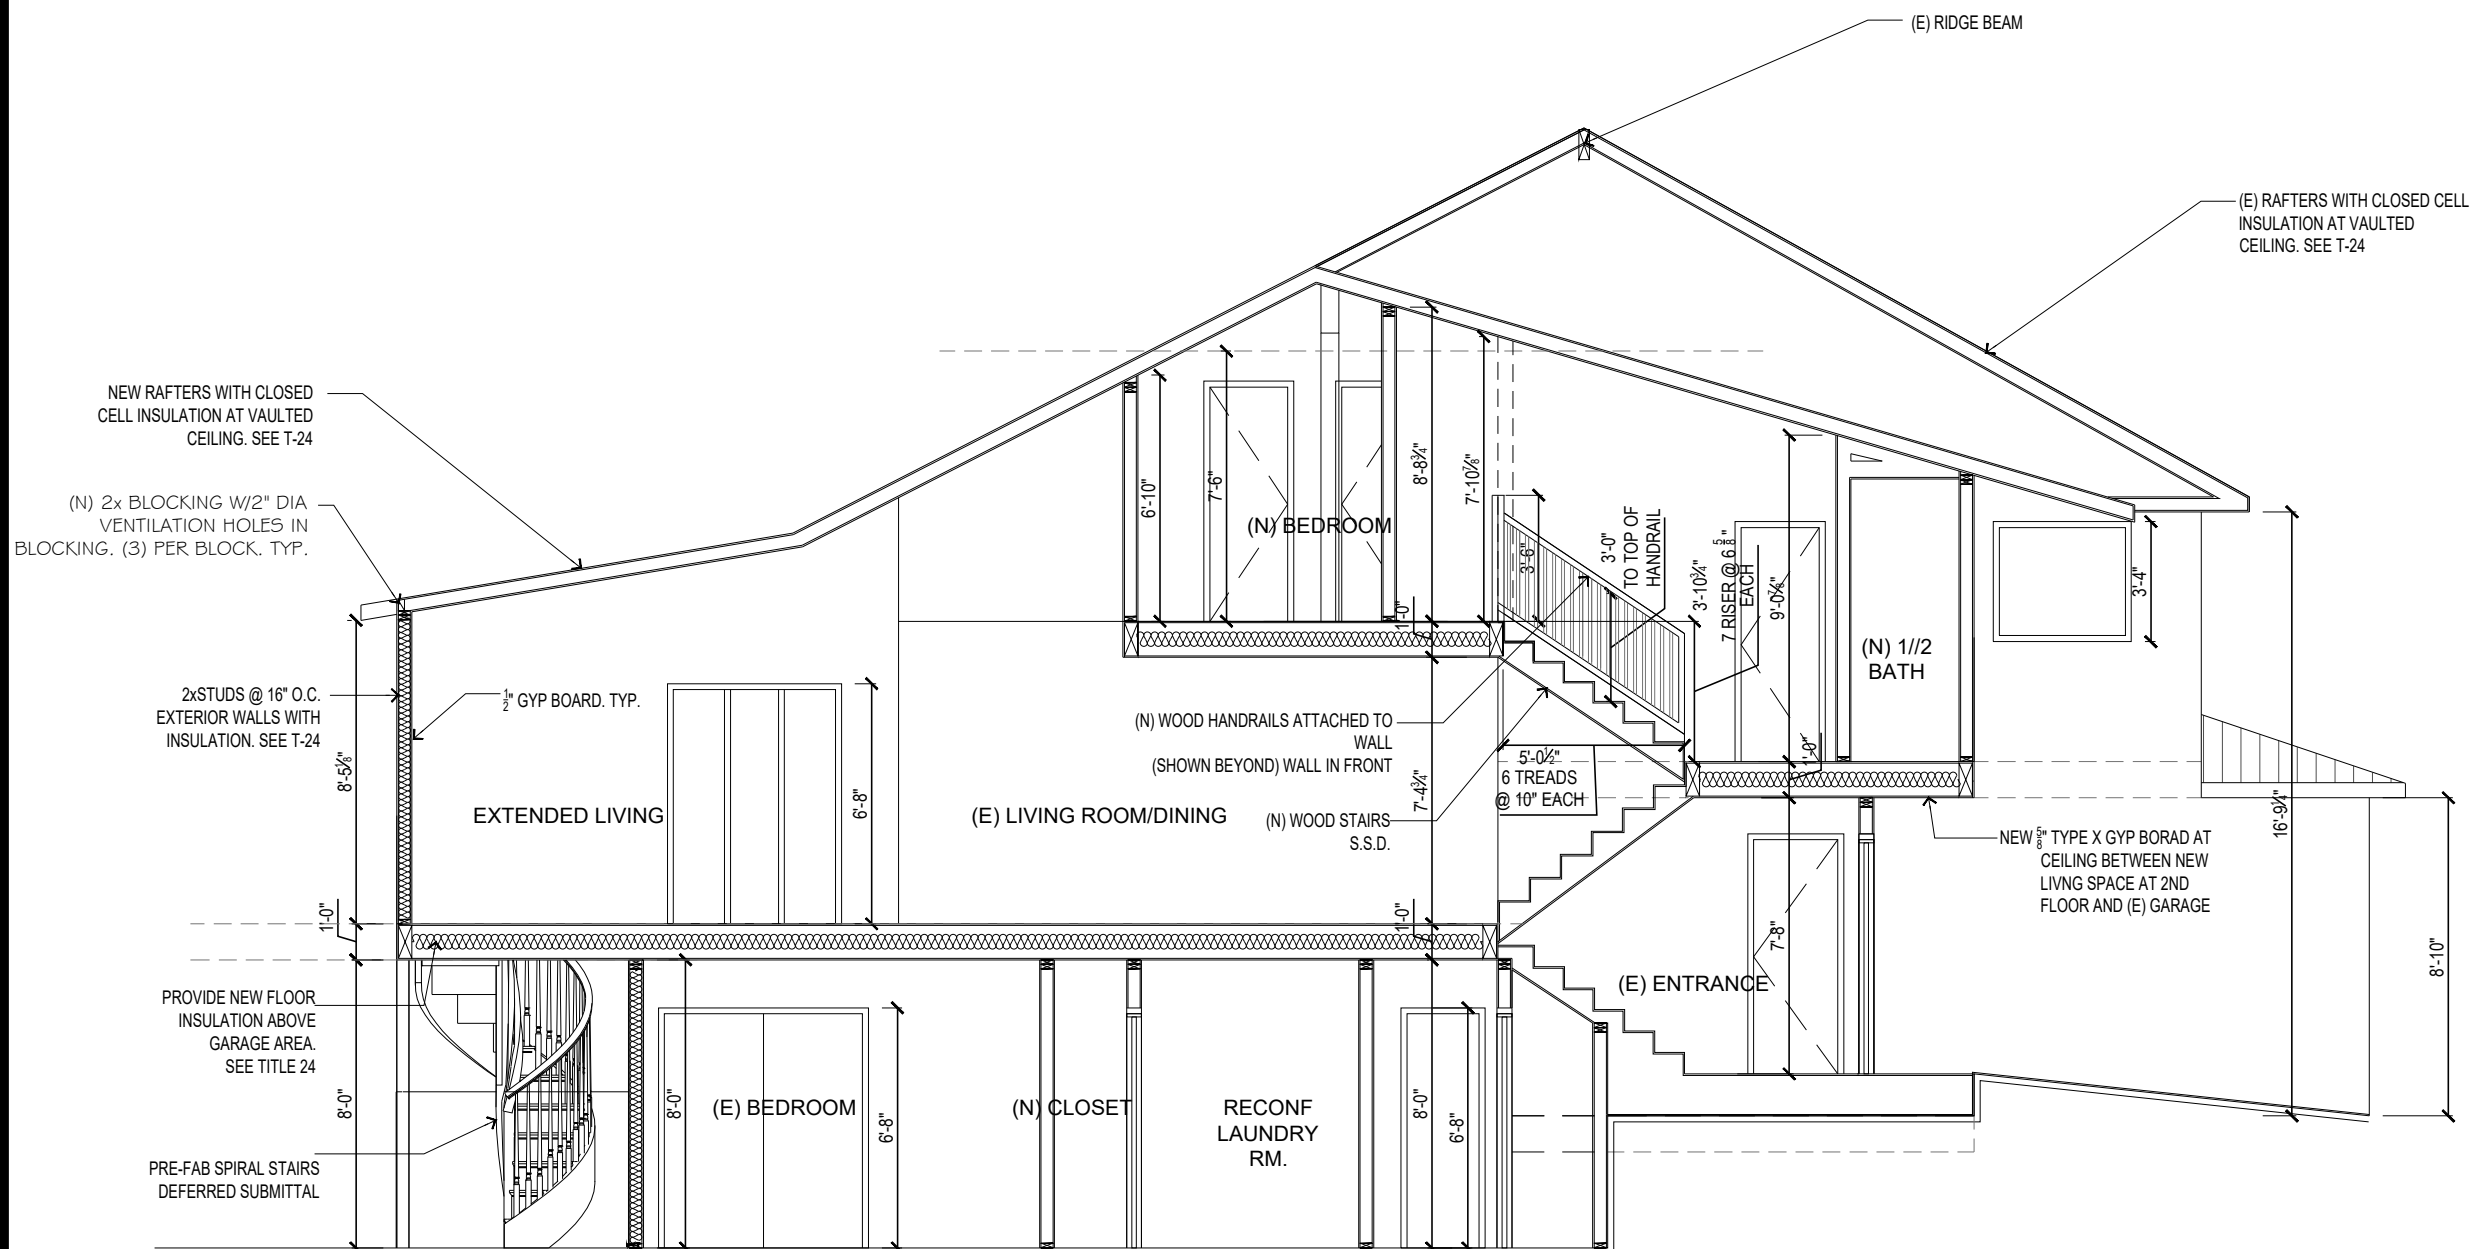

SCALE: 3/16" = 1'-0" 2



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<input type="radio"/> bidding	
<input type="radio"/> construction	

date 4.19.2024

um
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arch

AS NOTED

SECTIONS, DOOR AND WINDOW SCHEDULE AND DETAIL

sheet
number

A7.0



Leica DISTO™ Plan 11:22:33 20.09.2024



Leica DISTO™ Plan 11:20:47 20.09.2024



Leica DISTO™ Plan 11:15:07 20.09.2024



Leica DISTO™ Plan 11:16:18 20.09.2024



Leica DISTO™ Plan 11:18:23 20.09.2024

EXISTING PHOTO



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<input type="radio"/> construction	

date 4.19.2024

proj num

proj mgr

proj arch

scale AS NOTED

EXISTING PHOTO

sheet number A8.0



NEW FASICA & PAINT TO MATCH EXISTING




NEW DOWNSPOUT, GUTTER & PAINT TO MATCH EXISTING



NEW WINDOW TO MATCH EXISTING
FRAME INCLUDING TRIM

NEW DOOR

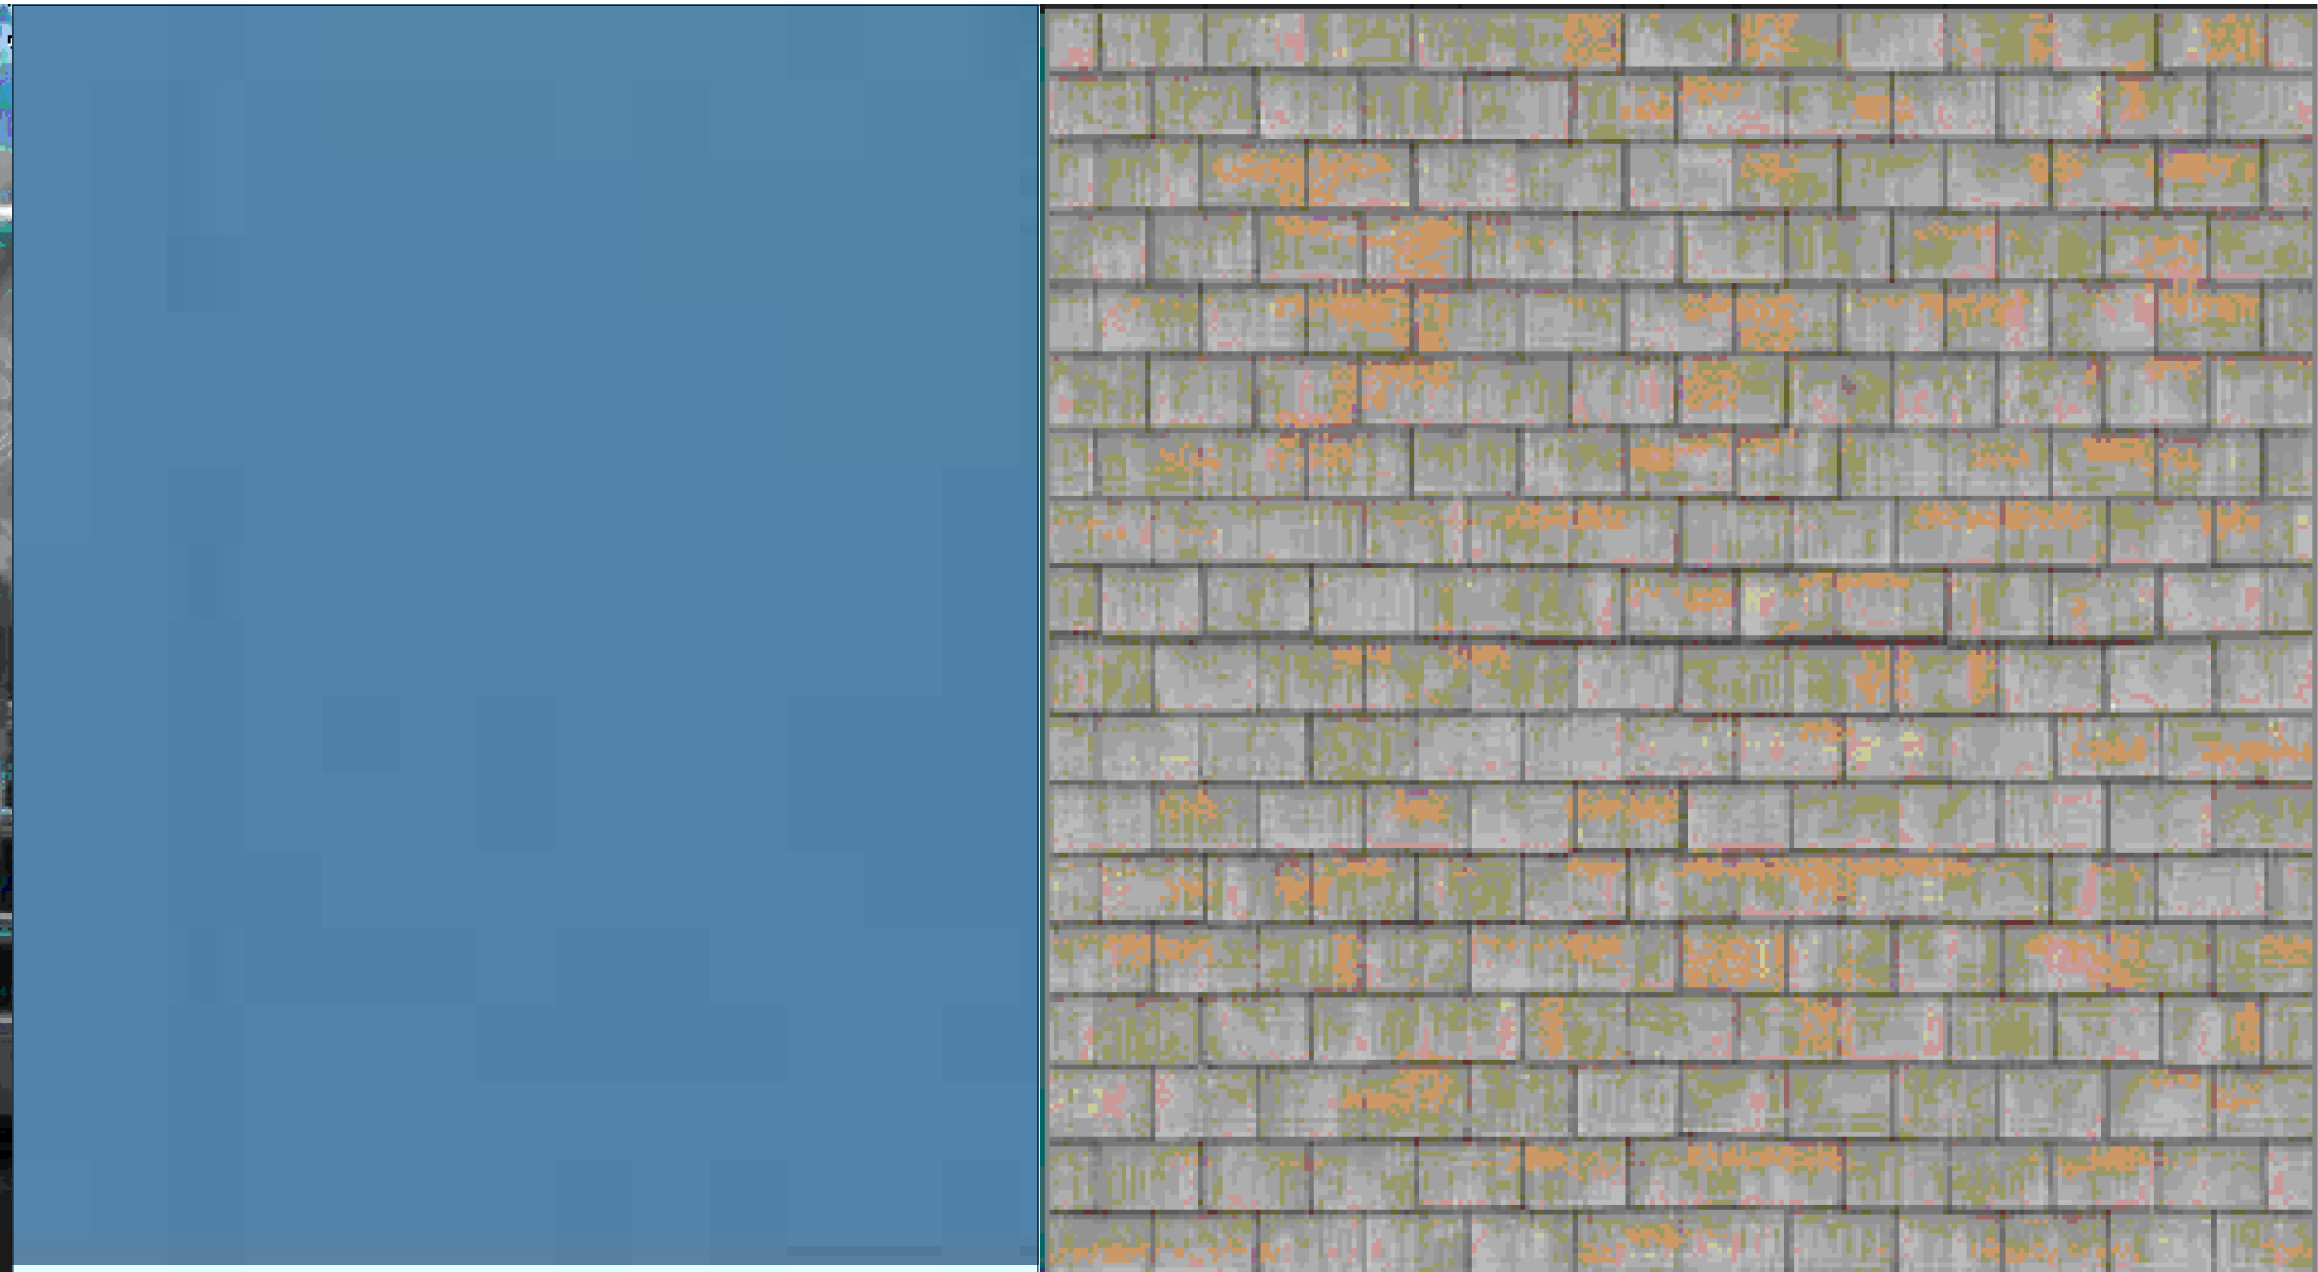

NEW EXTERIOR STUCCO TO
MATCH EXISTING

NEW SHINGLE ROOF TO
MATCH EXISTING



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<input type="radio"/> construction	

date

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proj mgr

proj arch

scale

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MATERIAL BOARD

sheet number
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	<input type="radio"/>	plan check	
	<input type="radio"/>	bidding	
		construction	

dat 4.19.2024

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4

AS NOTED

checklist

C1.0

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proj mgr

proj arch

scale

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checklist

C2.0